




**PROJECT** 

TRUE

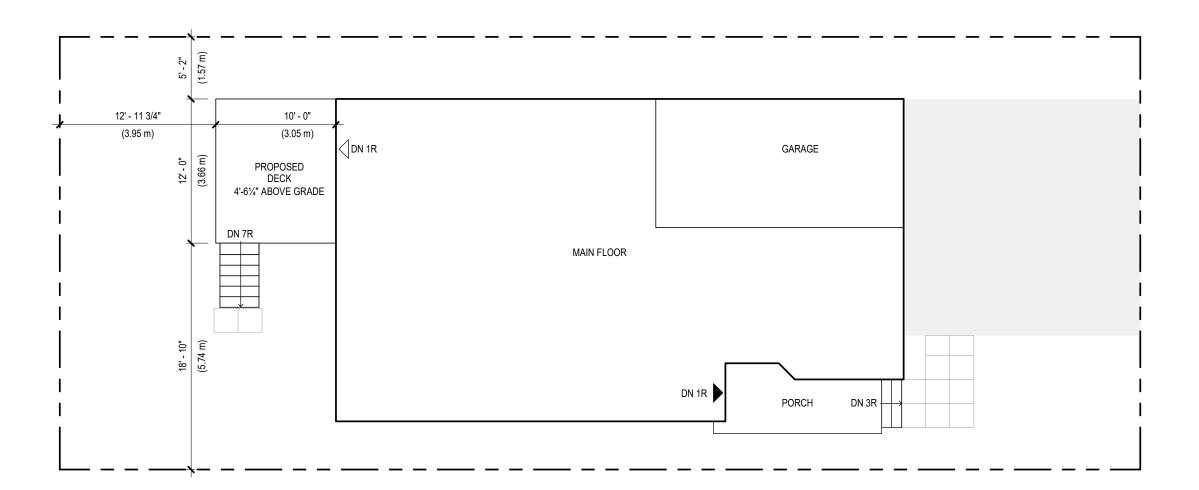



**NOTE** 

THE ITEMS ON THIS DRAWING, INCLUDING DIMENSIONS, ARE BEING PROVIDED TO SHOW THE DRAWING REQUIREMENTS FOR THE SITE PLAN ONLY. THEY DO NOT NECESSARILY REFLECT THE ACTUAL TOWN OF MILTON ZONING BY-LAW REQUIREMENTS FOR YOUR SPECIFIC PROPERTY. FOR SPECIFIC ZONING BY-LAW REQUIREMENTS FOR YOUR PROJECT CONTACT THE TOWN OF MILTON ZONING DEPARTMENT DIRECTLY AT (905)878-7252 EXT. 2329

# **LEGEND**

PROPERTY LINE

24" x 24" CONCRETE PATIO STONE WALKWAY

# SAMPLE DRAWINGS



**BUILDING PERMIT APPLICATION GUIDE:** DECK

DRAWING NAME:

SITE PLAN

NUMBER OF COPIES REQUIRED: 2 (5 WHEN SUBDIVISION IS NOT ASSUMED)

DRAWING MUST INCLUDE/SHOW (IF APPLICABLE):

- STRUCTURES:
   HOUSE (INCLUDING PORCH & EXTERIOR STAIRS)
- ACCESSORY BUILDINGS (SHED/GARAGE)
- POOL

## HARD LANDSCAPED SURFACES:

- DRIVEWAY
- WALKWAYS/PATIOS

### **SETBACKS**:

- DECK TO PROPERTY LINES
- REAR WALL OF HOUSE TO REAR PROPERTY LINE

### **DIMENSIONS:**

# **GENERAL/OTHER NOTES:**

- DECK HEIGHT ABOVE GRADE (AT LOWEST POINT OF GRADE)


- LEGEND OF LINE TYPES, SYMBLOLS, AND HATCHING USED


DESIGNER: JOE SMITH


PROJECT 123 MAIN STREET ADDRESS: MILTON, ONTARIO

SHEET SIZE: 11" X 17" DATE: JUNE 2018 SHEET NO.

SCALE: AS INDICATED

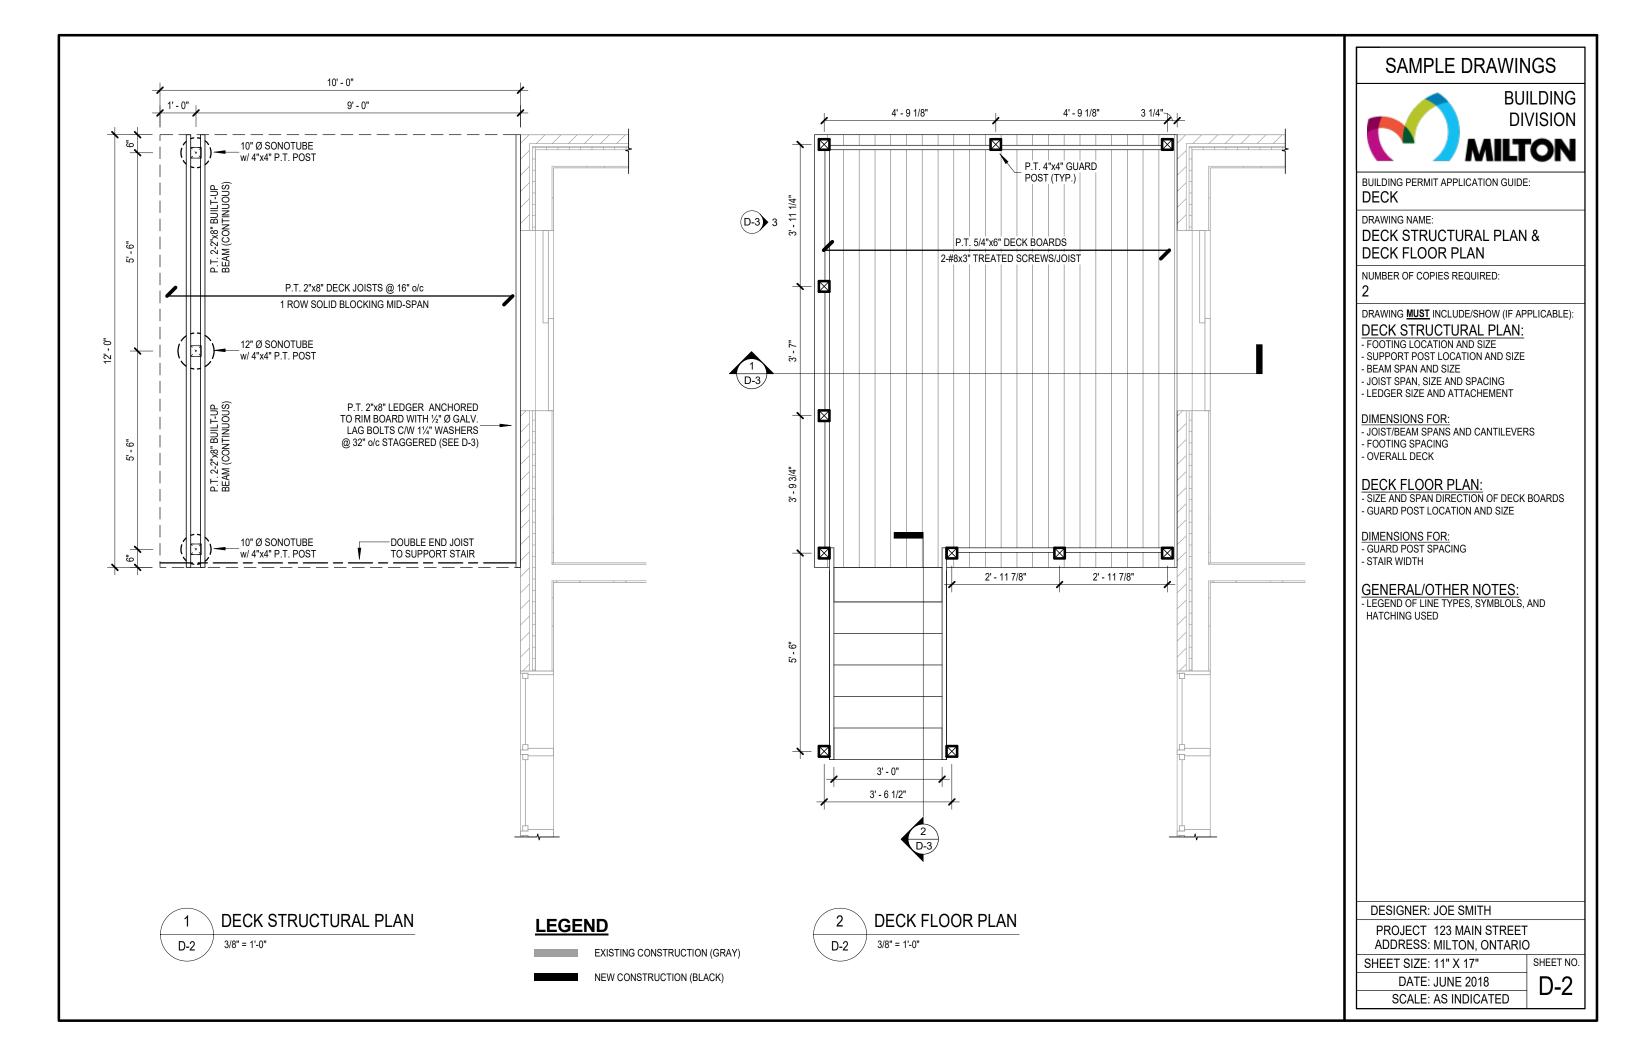

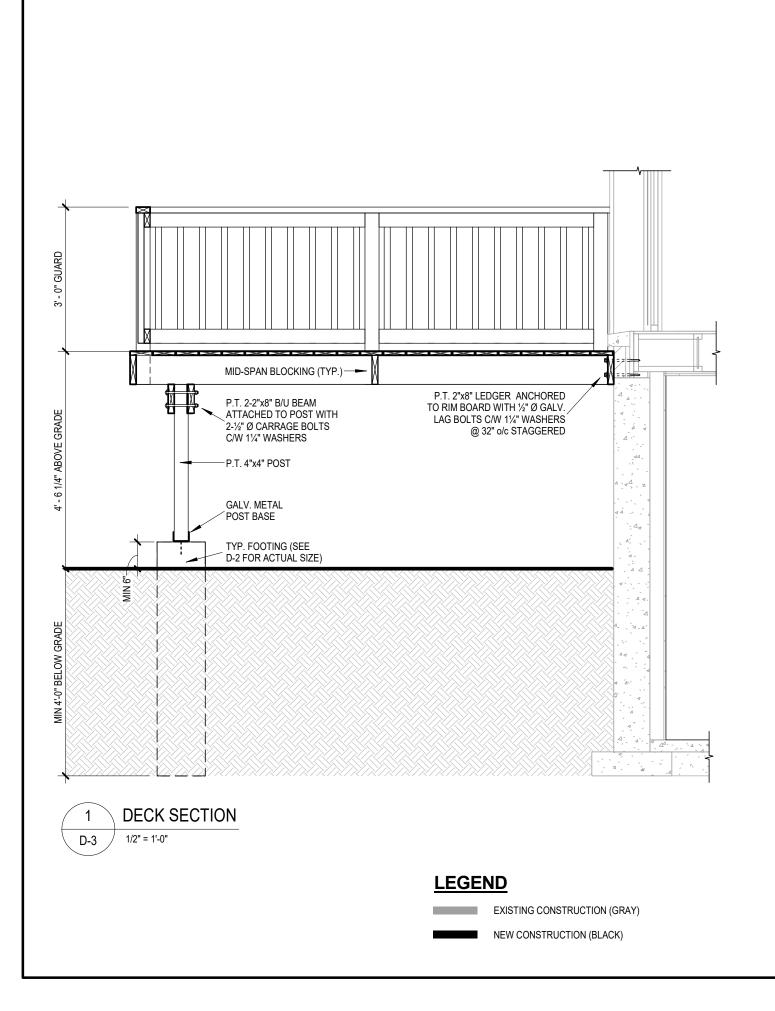

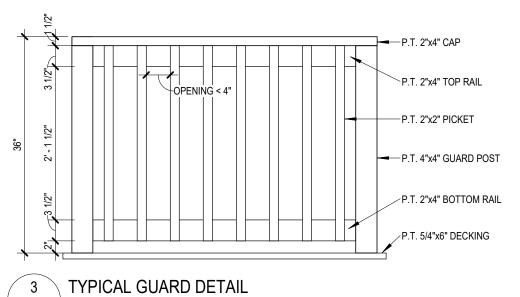


3/4" = 1'-0"

D-3

D-3

1/2" = 1'-0"

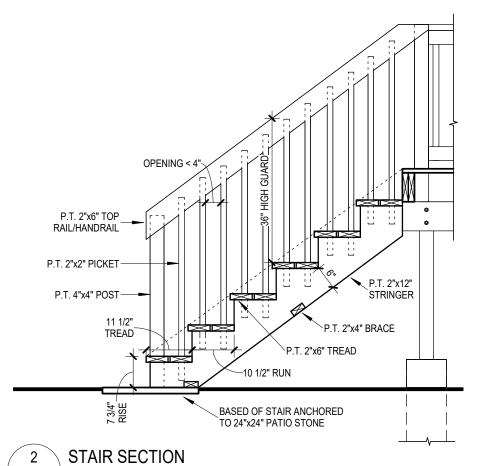

# SAMPLE DRAWINGS



BUILDING PERMIT APPLICATION GUIDE: DECK

DRAWING NAME:

**DECK SECTIONS & DETAILS** 

NUMBER OF COPIES REQUIRED:

2

DRAWING MUST INCLUDE/SHOW (IF APPLICABLE): DECK SECTION:

### FOOTING

- FOOTING
- SUPPORT POST AND METAL POST BASE
- BEAM SIZE AND ATTACHENT TO POST - LEDGER SIZE AND ATTACHMENT TO HOUSE

### DIMENSIONS FOR:

- HEIGHT OF DECK ABOVE GRADE (AT LOWEST POINT OF GRADE)
- OVERALL GUARD HEIGHT
- FOOTING DEPTH BELOW GRADE

### TYPICAL GUARD DETAIL

GUARDS ARE REQUIRED WHEN THE FINISHED DECK FLOOR IS 24" OR MORE ABOVE GRADE

- SIZE AND LOCATION OF POSTS, BOTTOM/TOP RAIL. TOP CAP AND PICKETS

**NOTE**: AN ENGINEERED STAMPED DETAIL IS REQUIRED FOR ANY GUARD SYSTEM:

- THAT INCORPORATES ANY
- COMPONENET THAT IS NOT WOOD, OR
   IS BUILT HIGHER THAN 3'-6" (SUCH AS A
  PRIVACY SCREEN SERVING AS A GUARD)
- DIMENSIONS FOR:
- OVERALL GUARD HEIGHT
- THE TOP AND BOTTOM OF ALL HORIZONTAL COMPONENTS OF THE GUARD (BOTTOM/TOP RAIL, CAP, ETC.)
- SPACING BETWEEN PICKETS

### STAIR SECTION:

- SIZE OF STRINGER, TREADS AND RISERS
- GUARD POST LOCATION AND SIZE

### **DIMENSIONS FOR:**

- OVERALL GUARD HEIGHT
- STAIR RISE, RUN AND TREAD DEPTH - EFFECTIVE DEPTH OF STAIR STRINGER

# GENERAL/OTHER NOTES:

- LEGEND OF LINE TYPES, SYMBLOLS, AND HATCHING USED

DESIGNER: JOE SMITH


PROJECT 123 MAIN STREET ADDRESS: MILTON, ONTARIO


SHEET SIZE: 11" X 17"

SHEET NO.

DATE: JUNE 2018
SCALE: AS INDICATED

D-3

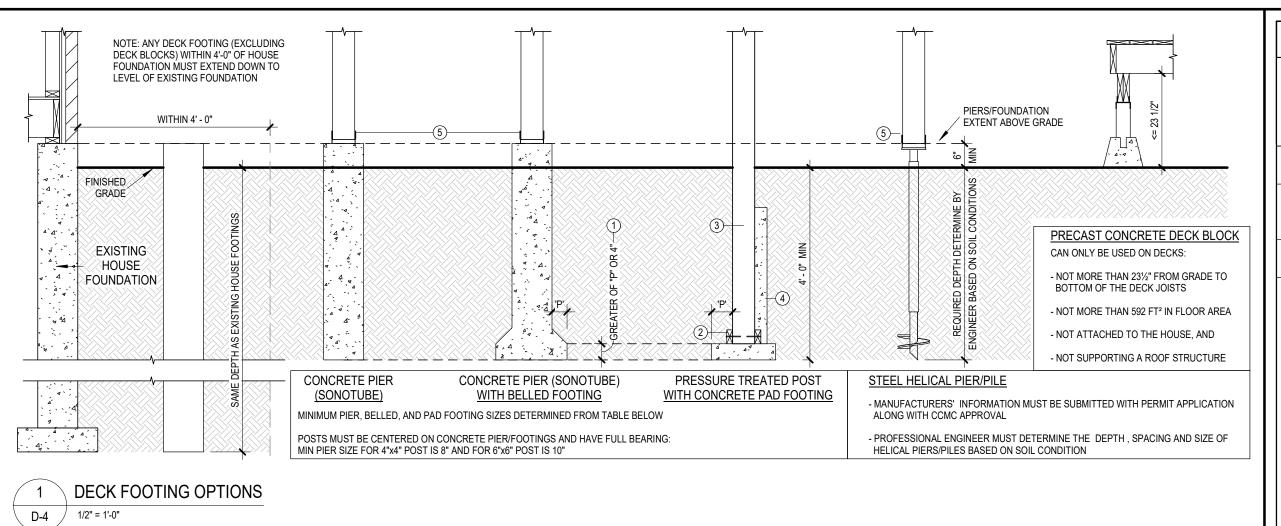

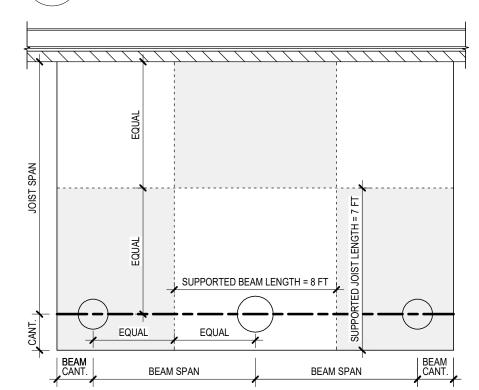

D-4

### REQUIRED DECK FOOTINGS CAPACITY

FOOTING LOAD = SUPPORTED BEAM LENGTH x SUPPORTED JOIST LENGTH x 40 LBS/FT2 (DECK LOAD)

USE FOOTING/PIER SIZING TABLE BELOW TO DETERMINE MINIMUM FOOTING SIZE BASED ON FOOTING LOAD

### **EXAMPLE (MIDDLE FOOTING):**

SUPPORTED BEAM LENGTH = 8 FT SUPPORTED JOIST LENGTH = 7 FT FOOTING LOAD = 8 FT x 7 FT x 40 LBS/FT<sup>2</sup> = 2240 LBS

MIDDLE FOOTING WOULD REQUIRE MIN 16" ROUND FOOTING OR 14" SQUARE FOOTING


### FOOTING/PIER SIZING TABLE

MINIMUM	MAX. FOOTING CAPACITY			
FOOTING SIZE	ROUND (DIA)	SQUARE		
8"	729 LBS	928 LBS		
10"	1139 LBS	1450 LBS		
12"	1640 LBS	2089 LBS		
14"	2233 LBS	2843 LBS		
16"	2916 LBS	3713 LBS		
18"	3691 LBS	4699 LBS		

NOTE: MAX FOOTING CAPACITY BASED ON A SOIL BEARING CAPACITY OF 2000 LBS/FT2


## FLOOR JOIST SPAN TABLE

JOIST SIZE	SPACING (o/c)	MAX. JOIST SPAN	MAX. JOIST CANTILEVER		
2"x6"	12"	10'-4"	NOT		
	16"	9'-4"	NOT PERMITTED		
	24"	8'-2"	TERWITTED		
2"x8"	12"	12'-5"	LESSER OF 16" OR 1/7 OF TOTAL		
	16"	11'-9"			
	24"	10'-9"	JOIST LENGTH		
2"x10"	12"	14'-6"			
	16"	13'-9"			
	24"	12'-10"	LESSER OF 24" OR 1/7 OF TOTAL JOIST LENGTH		
2"x12"	12"	16'-4"			
	16"	15'-5"			
	24"	14'-6"			

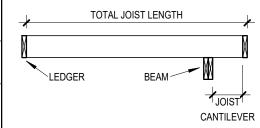

## **BEAM SPAN TABLE**

SUPPORTED	MAX. 2-PLY BEAM SPAN			MAX. 3-PLY BEAM SPAN				
JOIST LENGTH	2"x6"	2"x8"	2"x10"	2"x12"	2"x6"	2"x8"	2"x10"	2"x12"
4'-0"	8'-0"	10'-4"	12'-7"	14'-7"	9'-7"	12'-7"	16'-1"	19'-7"
6'-0"	6'-10"	8'-4"	10'-4"	11'-9"	8'-4"	11'-0"	14'-1"	17'-1"
8'-0"	5'-11"	7'-2"	8'-10"	10'-3"	7'-7"	10'-0"	11'-10"	14'-1"
10'-0"	5'-3"	6'-5"	7'-10"	9'-2"	7'-1"	9'-4"	10'-10"	12'-7"
12'-0"	4'-10"	5'-11"	7'-2"	8'-4"	6'-8"	8'-7"	9'-11"	11'-6"
14'-0"	4'-6"	5'-5"	6'-8"	7'-9"	6'-4"	7'-11"	9'-2"	10'-8"

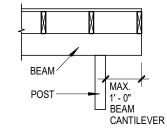

CALCULATING FOOTING SUPPORTING AREA AND MINIMUM FOOTING SIZE N.T.S.

STRUCTURAL SIZING TABLES

N.T.S. D-4

# SAMPLE DRAWINGS



**BUILDING PERMIT APPLICATION GUIDE: DECK** 

DRAWING NAME:

### **FOOTING OPTIONS &** STRUCTURAL SIZING INFO.

NUMBER OF COPIES REQUIRED:

N/A

## DRAWING MUST INCLUDE/SHOW (IF APPLICABLE): FOOTING NOTES:

- 1) MINIMUM DEPTH OF BELLED/PAD FOOTING IS THE GREATER OF 4" OR THE PROJECTION "P" OF THE BELLED/PAD FOOTING BEYOND THE
- (2) POST BEARING ON PAD FOOTING REQUIRES 2-2"x4" P.T. CLEATS FASTENED TO OPPOSITE SIDES OF THE POST WITH MIN. 3-31/2" GALVANIZED NAILS TO RESIST UPLIFT. CLEATS SHALL EXTEND MIN 2" PAST EITHER SIDE OF POST
- (3) BURIED PRESSURE TREATED POST MUST BE RATED FOR GROUND CONTACT
- (4) OPTIONAL CONCRETE BACKFILL AROUND
- 5 POST SADDLE ANCHORED TO CONCRETE/STEEL HELICAL PIER/PILE.

### FOOTING SIZING NOTES:

DECKS FOOTING SUPPORTING ROOF OR OTHER STRUCTURES (HOT TUB, ETC.) MUST INCLUDE THE WEIGHT OF THESE STRUCTURES IN THE FOOTING DESIGN

ROOF LOADING CAN BE TAKEN AT 30 LBS/FT2 HOT TUB LOADING WILL DEPEND IN SIZE AND DEPTH OF WATER (INCLUDE HOT TUB SPECIFICATIONS WITH PERMIT APPLICATION)

### JOIST/BEAM SPAN NOTES:

6) WHERE A DECK IS 2'-0" OR MORE ABOVE GRADE AND REQUIRES A GUARD OR WHERE A GUARD IS PROVIDED (BUT NOT REQUIRED) ON A LOWER DECK, THE MINIMUM FLOOR JOIST SIZE IS 2"x8"

**DESIGNER: JOE SMITH** 

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