



LEGEND:

- 1. PLAZA / SHADE
 2. FREE PLAY
 3. JUNIOR PLAY
 4. SENIOR PLAY
 5. SAND
 6. FITNESS AREA
 7. FITNESS TRAIL
 8. HALF COURT
 BASKETBALL

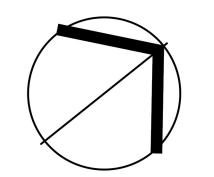





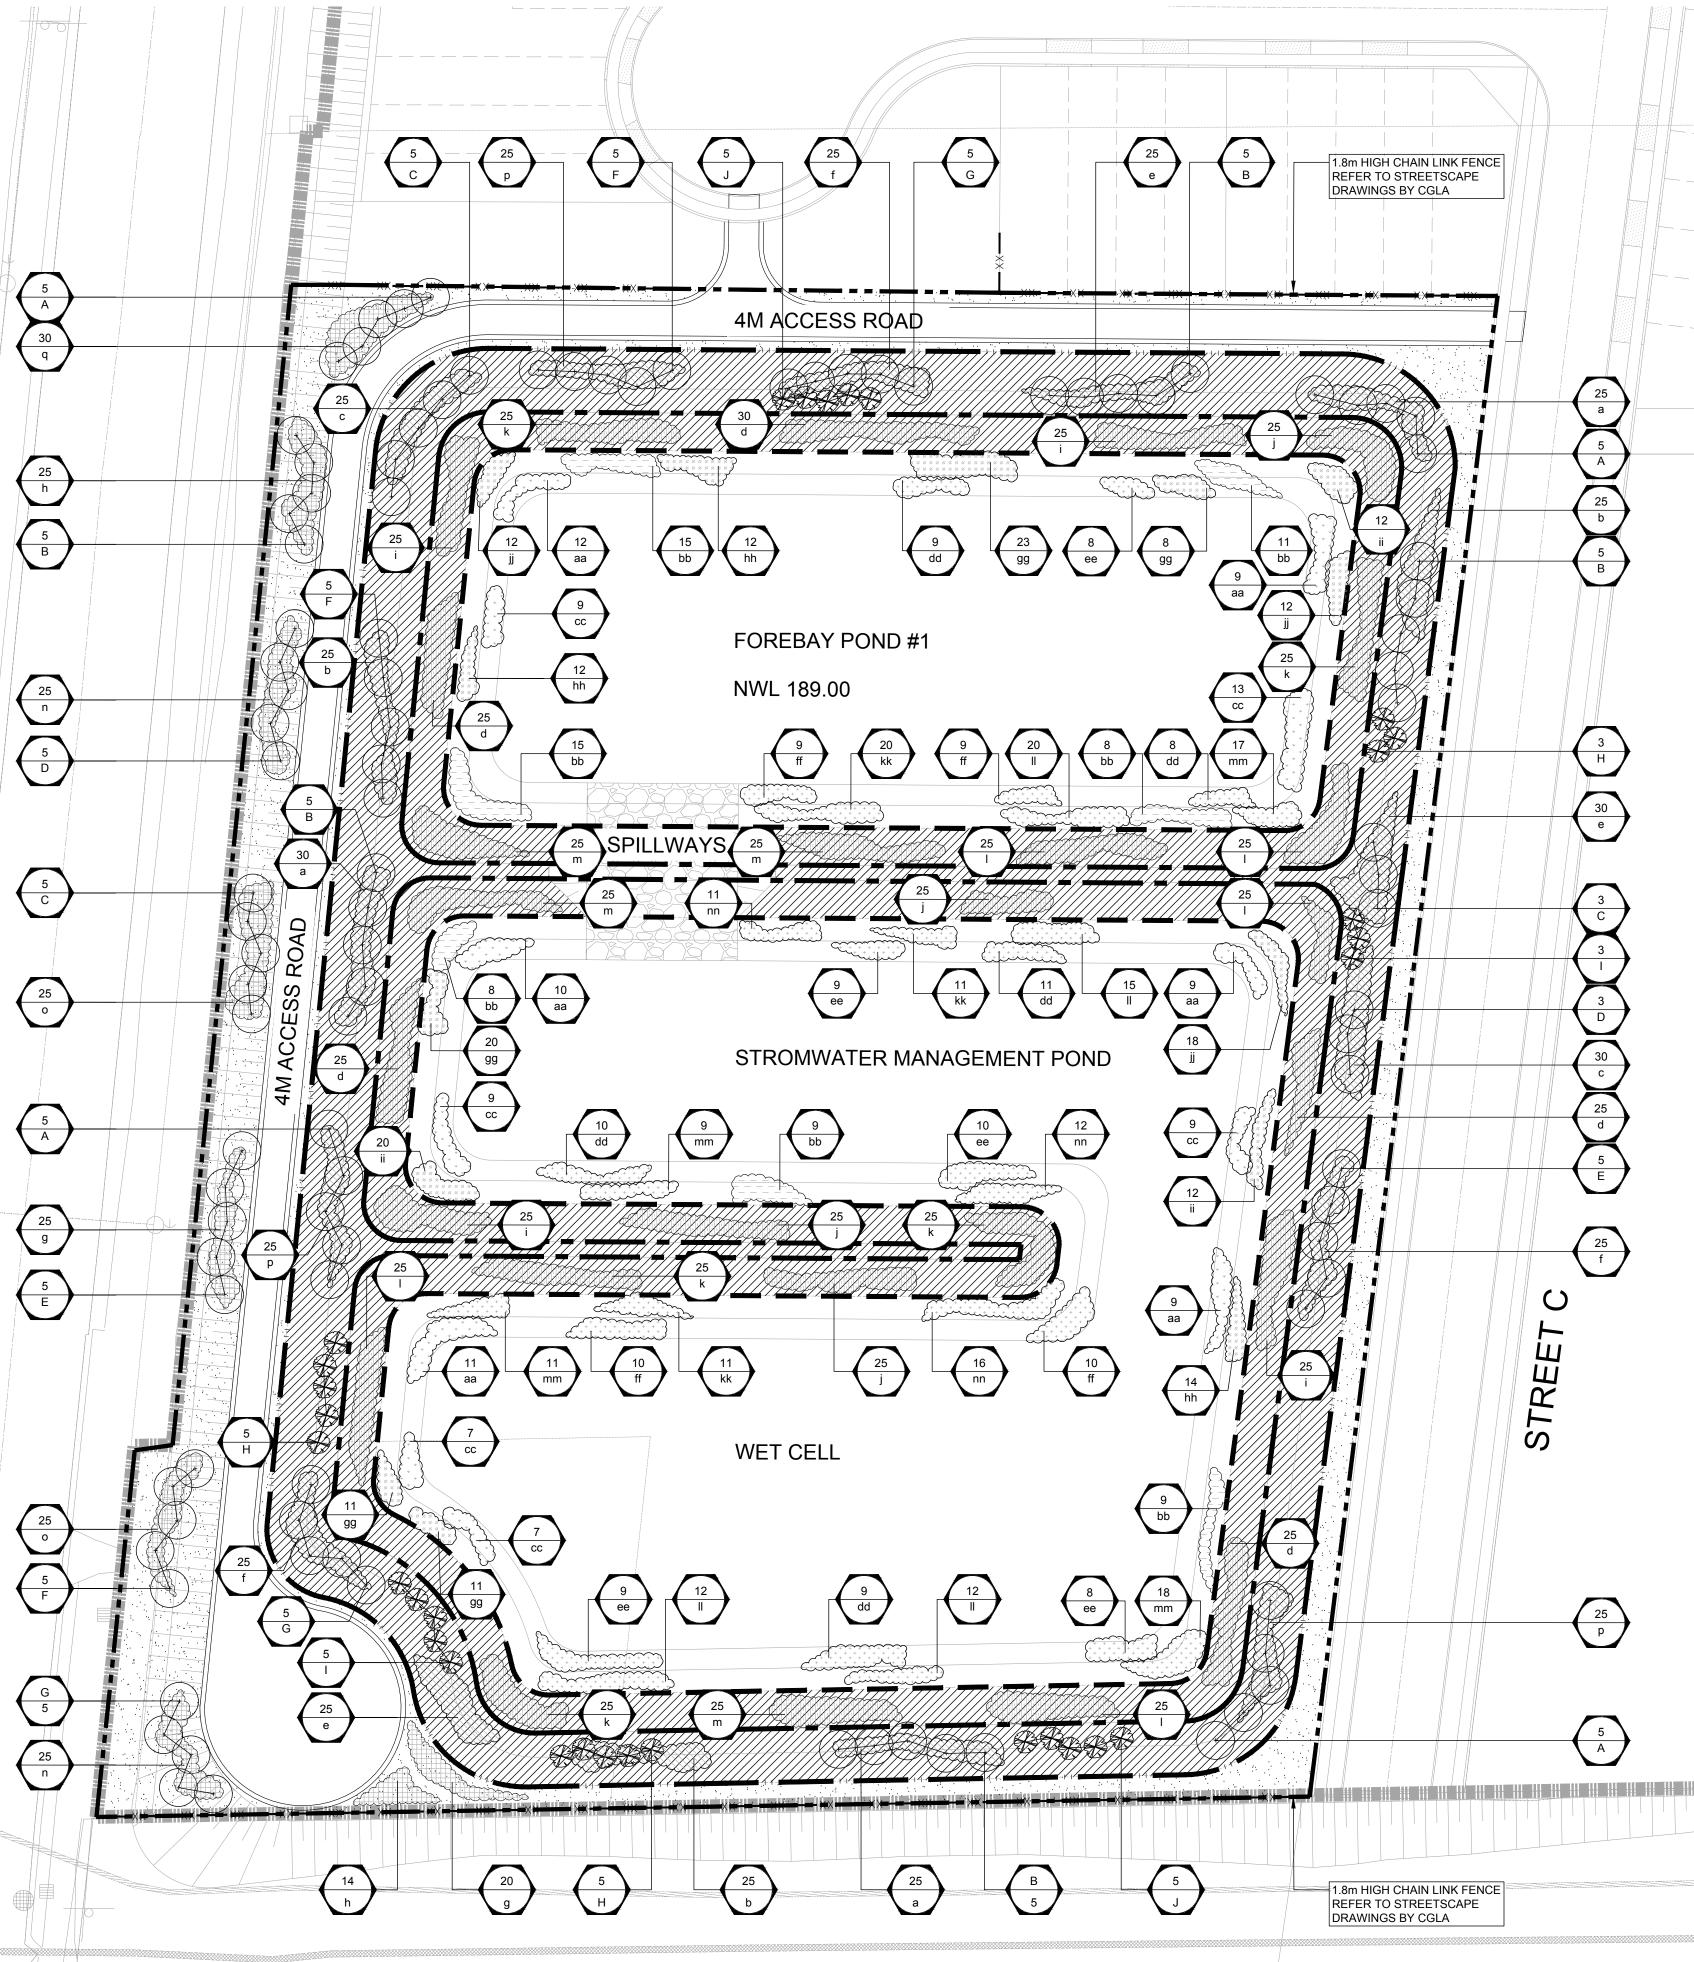

MA	STER P	<u>LANT LIOT</u>					
KE	Y TOT	AL BOTANICAL NAME	COMMON NAME	HEIGHT S	SPREAD CALIPER	COND.	REMARKS
DE	CIDUO	US TREES		(mm)	(mm) (mm)		
A	20	ACER SACCHARINUM	SILVER MAPLE	1500-3000	30-60	B&B	
В	25	FRAXINUS PENNSYLVANICA	GREEN ASH	1500-3000	30-60	B&B	
С	13	PINUS STROBUS	WHITE PINE	1500-3000	30-60	B&B	
D	8	POPULUS DELTOIDES	EASTERN COTTONWOOD	1500-3000	30-60	B&B	
E	10	QUERCUS ALBA	WHITE OAK	1500-3000	30-60	B&B	
F	15	QUERCUS BICOLOR	SWAMP WHITE OAK	1500-3000	30-60	B&B	
G	15	SALIX NIGRA	BLACK WILLOW	1500-3000	30-60	B&B	
ОТ	AL DEC	IDUOUS TREES: 106					
C	ONIFER	OUS TREES					
Н	13	PICEA GLAUCA	WHITE SPRUCE	1500-2500	30-50	B&B	
I	8	PINUS STROBUS	EASTERN WHITE PINE	2000-3000	30-60	B&B	
J	10	THUJA OCCIDENTALIS	EASTERN WHITE CEDAR	1500-2500	30-50	B&B	
ΤΟ	TAL COI	NIFEROUS TREES: 31					
TO	TAL COI	NIFEROUS TREES: 31					
			COMMON NAME		PREAD		
ΚΕΥ			COMMON NAME	HEIGHT SF (mm)	PREAD		
ΚΕΥ	′ TOTA		COMMON NAME DOWNY JUNEBERRY		PREAD		
KEY SHF	' TOTA RUBS 80 75	L BOTANICAL NAME AMELANCHIER ARBOREA AMELANCHIER LAEVIS WIEGAND		(mm) 600 600	PREAD		
KEY SHF	′∣ TOTA RUBS 80 75 55	L BOTANICAL NAME AMELANCHIER ARBOREA AMELANCHIER LAEVIS WIEGAND CEPHALANTHUS OCCIDENTALIS	DOWNY JUNEBERRY SMOOTH JUNEBERRY BUTTONBUSH	(mm) 600 600 600	PREAD		
(EY SHF	' TOTA RUBS 80 75 55 105	L BOTANICAL NAME AMELANCHIER ARBOREA AMELANCHIER LAEVIS WIEGAND CEPHALANTHUS OCCIDENTALIS CORNUS STOLONIFERA	DOWNY JUNEBERRY SMOOTH JUNEBERRY BUTTONBUSH RED-OSIER DOGWOOD	(mm) 600 600 600 600	PREAD		
(EY SHF	Y TOTA RUBS 80 75 55 105 80	L BOTANICAL NAME AMELANCHIER ARBOREA AMELANCHIER LAEVIS WIEGAND CEPHALANTHUS OCCIDENTALIS CORNUS STOLONIFERA DIERVILLA LONICERA	DOWNY JUNEBERRY SMOOTH JUNEBERRY BUTTONBUSH RED-OSIER DOGWOOD BUSH HONEYSUCKLE	(mm) 600 600 600 600	PREAD		
(EY SHF	' TOTA RUBS 80 75 55 105	L BOTANICAL NAME AMELANCHIER ARBOREA AMELANCHIER LAEVIS WIEGAND CEPHALANTHUS OCCIDENTALIS CORNUS STOLONIFERA	DOWNY JUNEBERRY SMOOTH JUNEBERRY BUTTONBUSH RED-OSIER DOGWOOD	(mm) 600 600 600 600	PREAD		
KEY SHF	Y TOTA RUBS 80 75 55 105 80 75	L BOTANICAL NAME AMELANCHIER ARBOREA AMELANCHIER LAEVIS WIEGAND CEPHALANTHUS OCCIDENTALIS CORNUS STOLONIFERA DIERVILLA LONICERA ILEX VERTICILLATA	DOWNY JUNEBERRY SMOOTH JUNEBERRY BUTTONBUSH RED-OSIER DOGWOOD BUSH HONEYSUCKLE WINTERBERRY	(mm) 600 600 600 600 600	PREAD		
(EY SHF	Y TOTA RUBS 80 75 55 105 80 75 45	L BOTANICAL NAME AMELANCHIER ARBOREA AMELANCHIER LAEVIS WIEGAND CEPHALANTHUS OCCIDENTALIS CORNUS STOLONIFERA DIERVILLA LONICERA ILEX VERTICILLATA RHUS TYPHINA	DOWNY JUNEBERRY SMOOTH JUNEBERRY BUTTONBUSH RED-OSIER DOGWOOD BUSH HONEYSUCKLE WINTERBERRY STAGHORN SUMAC	(mm) 600 600 600 600 600 600 600	PREAD		
(EY SHF	Y TOTA RUBS 80 75 55 105 80 75 45 39	AMELANCHIER ARBOREA AMELANCHIER LAEVIS WIEGAND CEPHALANTHUS OCCIDENTALIS CORNUS STOLONIFERA DIERVILLA LONICERA ILEX VERTICILLATA RHUS TYPHINA RIBES AMERICANUM	DOWNY JUNEBERRY SMOOTH JUNEBERRY BUTTONBUSH RED-OSIER DOGWOOD BUSH HONEYSUCKLE WINTERBERRY STAGHORN SUMAC WILD BLACK CURRANT	(mm) 600 600 600 600 600 600 600	PREAD		
(EY SHF	Y TOTA RUBS 80 75 55 105 80 75 45 39 100	AMELANCHIER ARBOREA AMELANCHIER LAEVIS WIEGAND CEPHALANTHUS OCCIDENTALIS CORNUS STOLONIFERA DIERVILLA LONICERA ILEX VERTICILLATA RHUS TYPHINA RIBES AMERICANUM RUBUS ALLEGHENIENSIS	DOWNY JUNEBERRY SMOOTH JUNEBERRY BUTTONBUSH RED-OSIER DOGWOOD BUSH HONEYSUCKLE WINTERBERRY STAGHORN SUMAC WILD BLACK CURRANT COMMON BLACKBERRY	(mm) 600 600 600 600 600 600 600 600	PREAD		
(EY SHF	Y TOTA RUBS 80 75 55 105 80 75 45 39 100 100	AMELANCHIER ARBOREA AMELANCHIER LAEVIS WIEGAND CEPHALANTHUS OCCIDENTALIS CORNUS STOLONIFERA DIERVILLA LONICERA ILEX VERTICILLATA RHUS TYPHINA RIBES AMERICANUM RUBUS ALLEGHENIENSIS SALIX ERIOCEPHALA	DOWNY JUNEBERRY SMOOTH JUNEBERRY BUTTONBUSH RED-OSIER DOGWOOD BUSH HONEYSUCKLE WINTERBERRY STAGHORN SUMAC WILD BLACK CURRANT COMMON BLACKBERRY HEART-LEAVED WILLOW	(mm) 600 600 600 600 600 600 600 600 600	PREAD		
(EY SHF	TOTA RUBS 80 75 55 105 80 75 45 39 100 100 100	AMELANCHIER ARBOREA AMELANCHIER LAEVIS WIEGAND CEPHALANTHUS OCCIDENTALIS CORNUS STOLONIFERA DIERVILLA LONICERA ILEX VERTICILLATA RHUS TYPHINA RIBES AMERICANUM RUBUS ALLEGHENIENSIS SALIX ERIOCEPHALA SALIX LUCIDA	DOWNY JUNEBERRY SMOOTH JUNEBERRY BUTTONBUSH RED-OSIER DOGWOOD BUSH HONEYSUCKLE WINTERBERRY STAGHORN SUMAC WILD BLACK CURRANT COMMON BLACKBERRY HEART-LEAVED WILLOW SHINING WILLOW	(mm) 600 600 600 600 600 600 600 600 600 60	PREAD		
(EY)	Y TOTA RUBS 80 75 55 105 80 75 45 39 100 100 100 100	AMELANCHIER ARBOREA AMELANCHIER LAEVIS WIEGAND CEPHALANTHUS OCCIDENTALIS CORNUS STOLONIFERA DIERVILLA LONICERA ILEX VERTICILLATA RHUS TYPHINA RIBES AMERICANUM RUBUS ALLEGHENIENSIS SALIX ERIOCEPHALA SALIX LUCIDA SAMBUCUS RACEMOSA SSP 'PUBENS'	DOWNY JUNEBERRY SMOOTH JUNEBERRY BUTTONBUSH RED-OSIER DOGWOOD BUSH HONEYSUCKLE WINTERBERRY STAGHORN SUMAC WILD BLACK CURRANT COMMON BLACKBERRY HEART-LEAVED WILLOW SHINING WILLOW RED-BERRIED ELDER	(mm) 600 600 600 600 600 600 600 600 600 60	PREAD		
(EY SHF	Y TOTA RUBS 80 75 105 80 75 45 39 100 100 100 100 100 100	AMELANCHIER ARBOREA AMELANCHIER LAEVIS WIEGAND CEPHALANTHUS OCCIDENTALIS CORNUS STOLONIFERA DIERVILLA LONICERA ILEX VERTICILLATA RHUS TYPHINA RIBES AMERICANUM RUBUS ALLEGHENIENSIS SALIX ERIOCEPHALA SALIX LUCIDA SAMBUCUS RACEMOSA SSP 'PUBENS' SAMBUCUS CANADENSIS	DOWNY JUNEBERRY SMOOTH JUNEBERRY BUTTONBUSH RED-OSIER DOGWOOD BUSH HONEYSUCKLE WINTERBERRY STAGHORN SUMAC WILD BLACK CURRANT COMMON BLACKBERRY HEART-LEAVED WILLOW SHINING WILLOW RED-BERRIED ELDER COMMON ELDER	(mm) 600 600 600 600 600 600 600 600 600 60	PREAD		

	TOTA	L BOTANICAL NAME	COMMON NAME	HEIGHT	SPREAD
GR	OUNDC	OVER		(mm)	
q	30	EUONYMUS OBOVATA	RUNNING STRAWBERRY-BUSH	600	

TOTAL GROUND COVER: 30

KEY	TOTAL	_ BOTANICAL NAME COM	MON NAME	HEIGHT	ZONE	COND.
ZONE ONE: DEEP WATER ZONE						
aa	60	ELODEA CANADENSIS	WATERWEED	100 min	SUB	POTTE
bb	75	NYMPHAEA ODORATA	FRAGRANT WATER-LILY	100 min	FL	POTTE
СС	54	POTAMOGETON PECTINATUS	SAGO PONDWEED	100 min	SUB	POTTE
dd	47	RUDBECKIA HIRTA	BLACK-EYED SUSAN	100 min		POTTE
ee	44	SAGITTARIA LATIFOLIA	COMMON ARROWHEAD	100 min		POTTE
ff	38	TYPHA LATIFOLIA	COMMON CATTAIL	100 min		POTTE
ZONE		AQUATIC ZONE	WATER DI ANTAINI	400 min	ENA	DILL
	TWO: <i>A</i>	AQUATIC ZONE ALISMA PLANTAGO-AQUATICA	WATER-PLANTAIN	100 min	EM	PLUC
ZONE gg hh	TWO: <i>A</i>	ALISMA PLANTAGO-AQUATICA CAREX BEBBII	BEBB'S SEDGE	100 min	EM	PLUG PLUG
ZONE 99	72 38 44	ALISMA PLANTAGO-AQUATICA CAREX BEBBII CAREX HYSTERICINA	BEBB'S SEDGE PORCUPINE SEDGE	100 min 150 min	EM EM	PLUC PLUC
ZONE 99 hh ii jj	72 38 44 42	ALISMA PLANTAGO-AQUATICA CAREX BEBBII CAREX HYSTERICINA CAREX VULPINOIDEA	BEBB'S SEDGE PORCUPINE SEDGE FOX SEDGE	100 min	EM	PLUG PLUG PLUG
ZONE gg hh	72 38 44 42 42	ALISMA PLANTAGO-AQUATICA CAREX BEBBII CAREX HYSTERICINA CAREX VULPINOIDEA JUNCUS DUDLEYI	BEBB'S SEDGE PORCUPINE SEDGE	100 min 150 min	EM EM	PLUG PLUG PLUG
ZONE 99 hh ii jj	72 38 44 42	ALISMA PLANTAGO-AQUATICA CAREX BEBBII CAREX HYSTERICINA CAREX VULPINOIDEA	BEBB'S SEDGE PORCUPINE SEDGE FOX SEDGE	100 min 150 min 150 min	EM EM	PLUC PLUC
ZONE 99 hh ii jj kk	72 38 44 42 42	ALISMA PLANTAGO-AQUATICA CAREX BEBBII CAREX HYSTERICINA CAREX VULPINOIDEA JUNCUS DUDLEYI	BEBB'S SEDGE PORCUPINE SEDGE FOX SEDGE DUDLEY'S RUSH	100 min 150 min 150 min 150 min	EM EM	PLUG PLUG PLUG PLUG

NOTE:

1. BARE ROOT PLANTING STOCK WILL BE SUBSTITUTED WITH POTTED MATERIAL IF THE PLANTING TAKES PLACE OUTSIDE THE BARE ROOT SEASON.

2. CONTRACTOR SHALL CONFIRM THAT ALL QUANTITIES SHOWN ON THE PLANT LIST CONFORM WITH THE PLANS.

THE QUANTITIES SHOWN ON THE PLAN SUPERSEDE THE TOTALS OF THE LIST. REPORT ANY DISCREPANCIES TO THE LANDSCAPE ARCHITECT.

GENERAL NOTES:

- THIS PLAN TO BE USED FOR STORMWATER MANAGEMENT POND NO.1 PLANTING WORKS ONLY.
- 2. BASE INFORMATION OBTAINED FROM FRONTENAC FOREST ESTATES INC.
- 3. LANDSCAPE CONTRACTOR SHALL PROVIDE LANDSCAPE ARCHITECT 48 HOURS NOTICE PRIOR TO COMMENCEMENT.

4. REFER TO DWGS SWM-2, SWM-4 FOR SEEDING PLAN, SWM-5
NOTES AND PLANT LIST, AND D1 FOR DETAILS.

+ DECIDUOUS TREES

PROPOSED EMERGENT AQUATICS

PROPOSED FLOATING AQUATICS

PROPOSED AQUATICS

PROPOSED
SUBMERGENT AQUATICS

PROPOSED SHORELINE FRINGE CONTINUOUS MULCH SHRUB BED

PROPOSED FLOOD FRINGE CONTINUOUS MULCH SHRUB BED

PROPOSED UPLAND
CONTINUOUS MULCH SHRUB BED


BANK STABILIZATION SEED MIX 'A'

UPLAND MEADOW SEED MIX 'B'

SPILLWAYS

R0 ISSUED FOR FIRST SUBMISSION

THESE DRAWINGS ARE THE PROPERTY OF CGLA CONSULTANTS INC. AND SHALL NOT BE ALTERED, MODIFIED, REVISED OR CHANGED WITHOUT THE WRITTEN CONSENT OF CGLA CONSULTANTS INC. SEAL IS NOT VALID WITHOUT SIGNATURE OF THE LANDSCAPE ARCHITECT. DRAWINGS CANNOT BE USED FOR TENDER/CONSTRUCTION UNTIL SIGNED BY LANDSCAPE ARCHITECT.

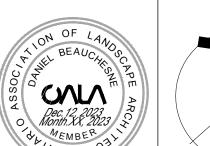



30 CENTURIAN DRIVE, UNIT 105
MARKHAM, ONTARIO, L3R 8B8
Telephone: 905-475-6988 Email info@cgla.ca www.cgla.ca

Client:
FRONTENAC FOREST
ESTATES INC.

Project Title:
FRONTENAC FOREST
TOWN OF MILTON

Drawing Title:
SWM POND
RESTORATION
LANDSCAPE PLAN


Reviewed: DB Drawn: CJ

Scale: 1:500 Date: 20250303

Project Number: 2813

Drawing Number

SWMP_1

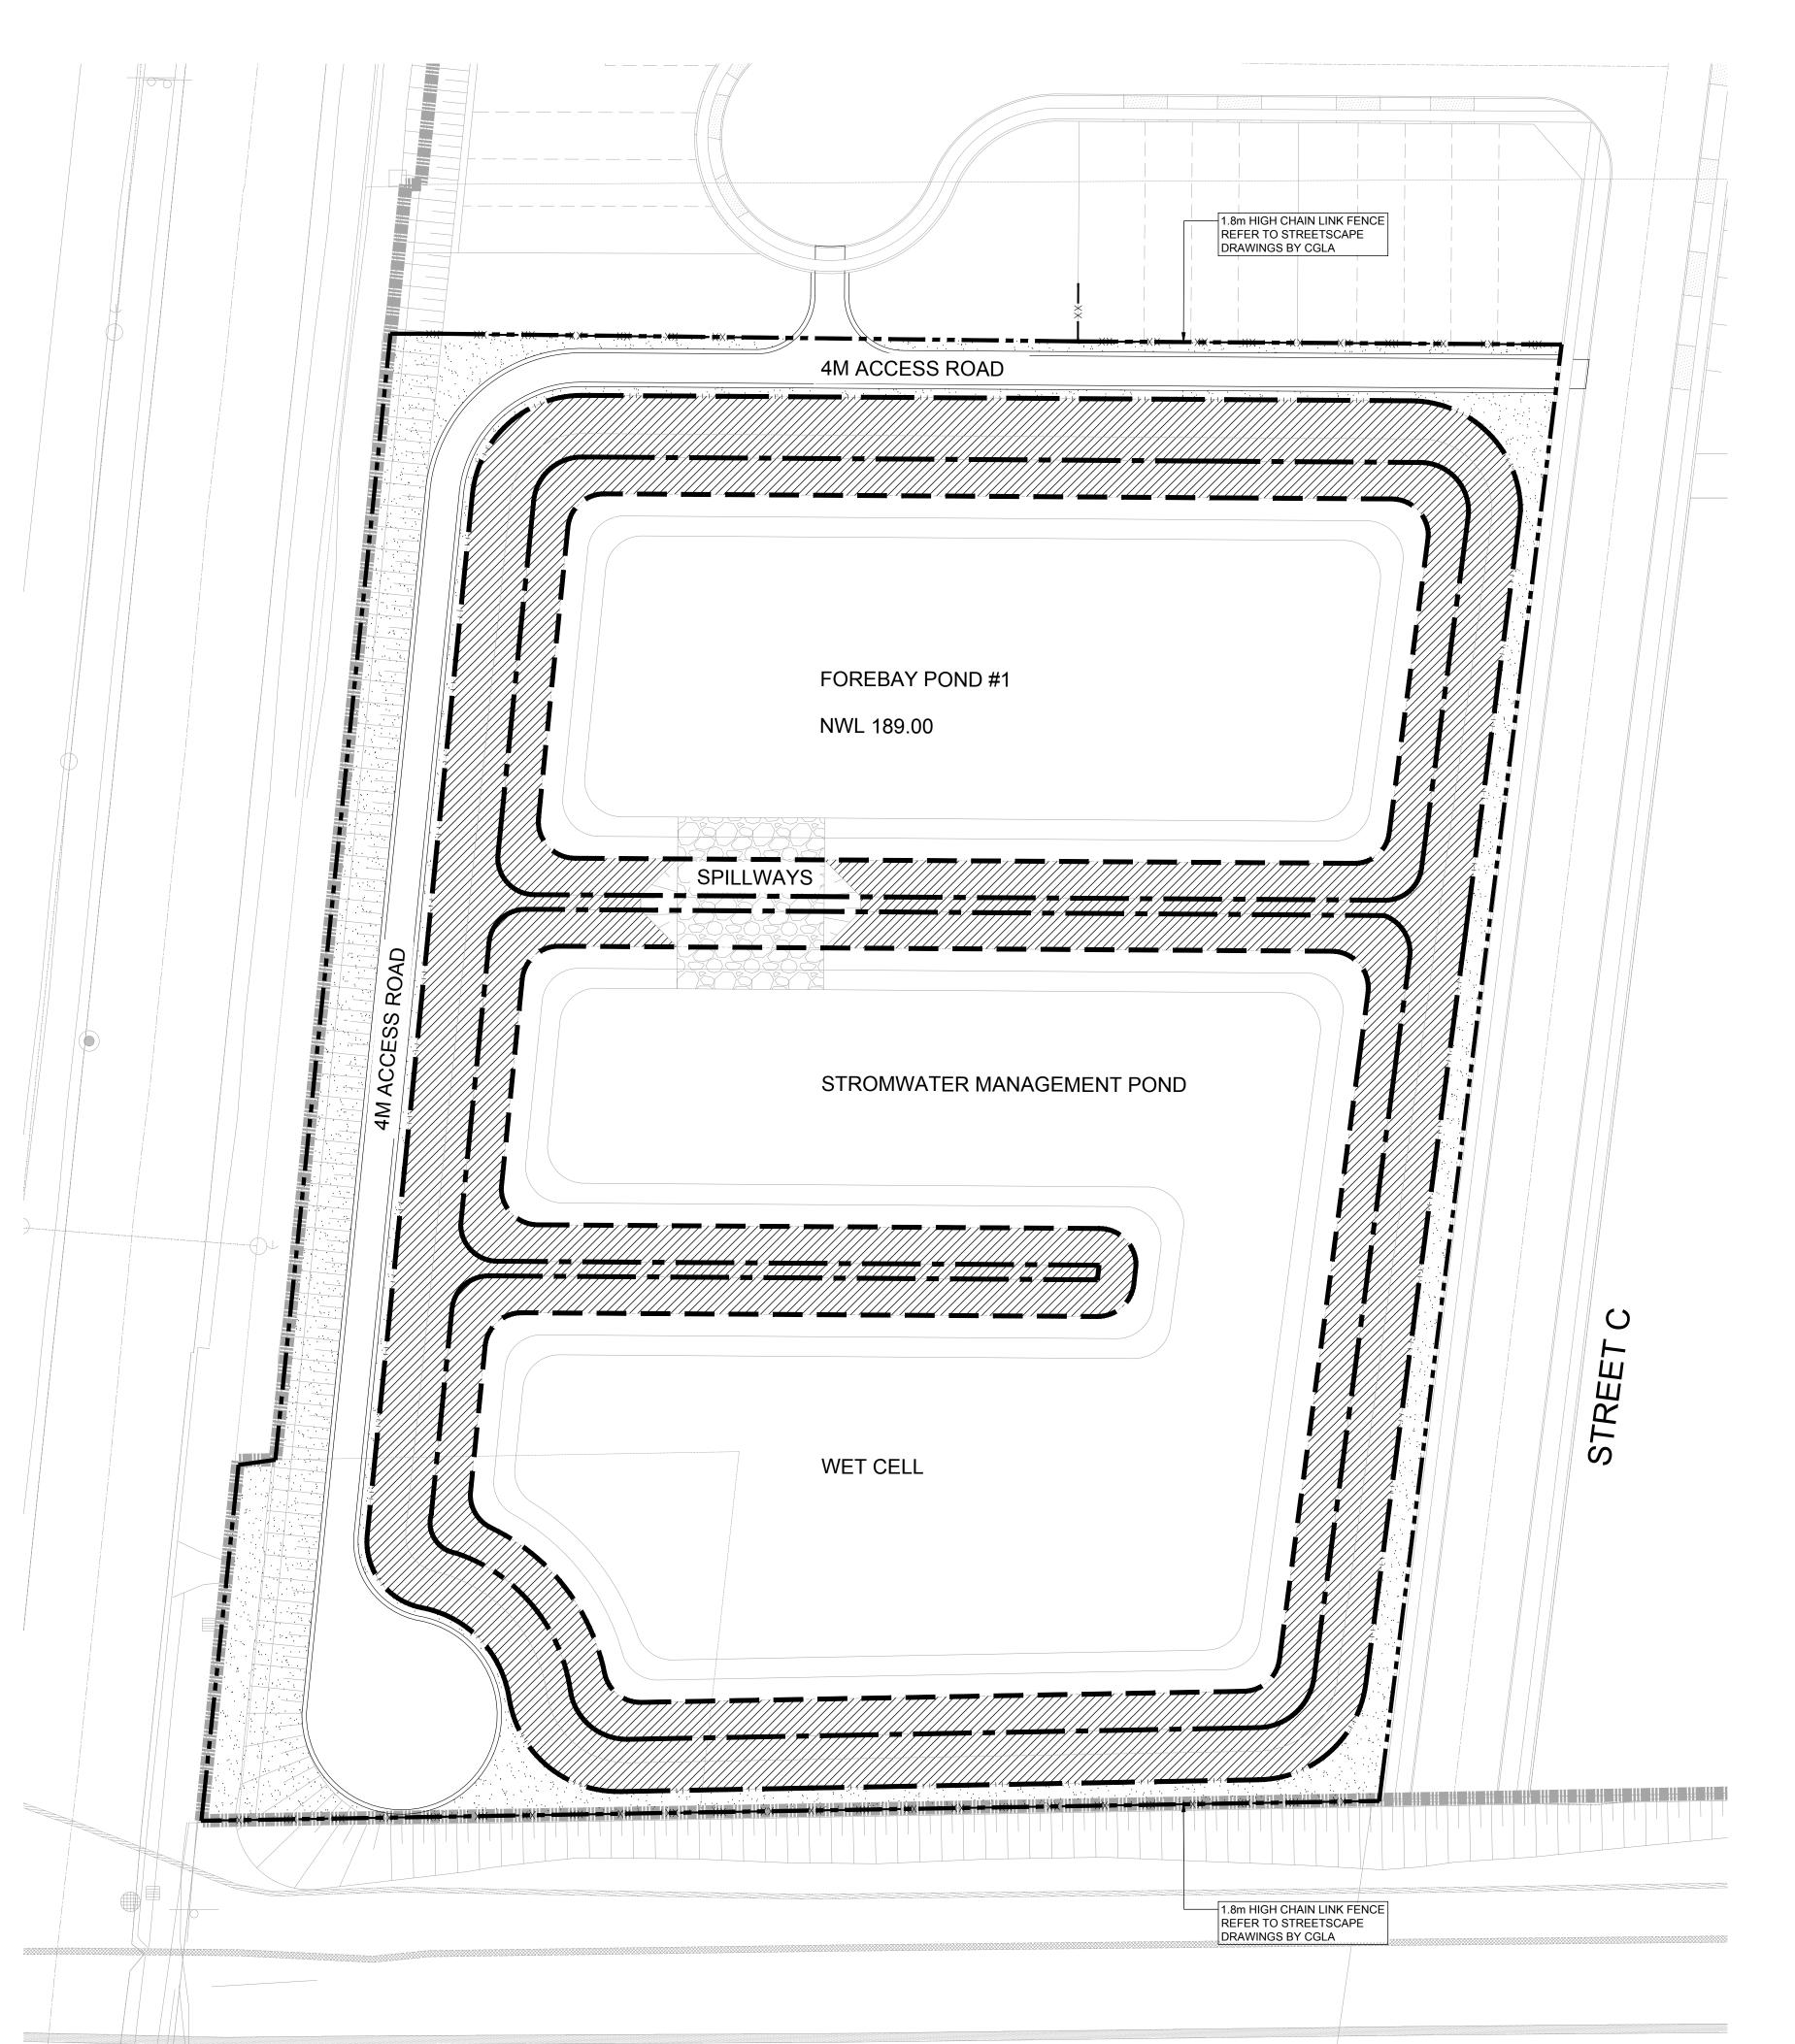

SEEDING NOTES:

SEED SHALL BE A PNEUMATICALLY APPLIED MIXTURE OF COMPOSTED ORGANICS PROVIDED BY LANDSOURCE ORGANICS LTD. (TERRASEEDING) OR APPROVED EQUAL APPLIED TO DEPTH OF 50mm. DO NOT FERTILIZE. SEEDING. ALL SEEDING SHALL BE COMPLETED

MAY 15 - JUNE 30 OR SEPTEMBER 1 - SEPTEMBER 21.

COVER CROP: ANNUAL OATS (Avena sativa) TO BE APPLIED IN ANY SEASON IF NECESSARY.

1ST GROWING SEASON - DO NOT CUT

2ND GROWING SEASON

- WATER BI-WEEKLY UNTIL ONSET OF FROST WITH SUFFICIENT AMOUNTS TO ENSURE GERMINATION

- WEED REMOVAL BY HAND AS NECESSARY

- ONCE SWARD HAS REACHED 100mm CUT BY HAND AT 50mm HEIGHT. ENSURE CUTTINGS ARE EJECTED

AWAY FROM OPEN WATER - CUT TO A HEIGHT OF 300mm IN MID-SUMMER, ONCE

BIENNIAL WEEDS SUCH AS SWEET CLOVER ARE IN FULL BLOOM

- CUT AGAIN IN OCTOBER TO A HEIGHT OF 150-300mm

3RD AND ALTERNATING - ONCE SWARD HAS REACHED A HEIGHT OF 100mm,

CUT BY HAND TO 50mm HEIGHT GROWING SEASONS

OPTIONAL TEMPORARY SEEDING (POND)

NOTE: ALL PROPOSED TOPSOIL AND SEEDED AREAS TO BE TEMPORARILY STABILIZED WITH ANNUAL OATS (AVENA SATIVA) TO BE APPLIED BY HAND, IN ANY SEASON. - SEEDING RATE 35KG/HA. - DO NOT FERTILIZE

- SHOULD FINAL PLANTING NOT PROCEED FOLLOWING ONE GROWING SEASON AREA TO BE RE-STABILIZED WITH ANNUAL OATS.

BANK STABILIZATION SEED MIX 'A'		TO NORMAL WATER LEVE ELEVATION 189.00 TOTAL AREA: 9632m2
% COMPOSITION	BOTANICAL NAME	COMMON NAME
	GRASSES	
20%	Andropogon gerardii	BIG BLUESTEM
15%	Calamagrostis canadensis	CANADA BLUE JOINT
10%	Elymus canadensis	CANADA WILD RYE
15%	Glyceria striata	FOWL MANNA GRASS
15%	Panicum virgatum	SWITCH GRASS
10%	Sorghastrum nutans	INDIAN GRASS
15%	FORBS	
100%	Asclepias incarnata	SWAMP MILKWEED
.00,0	Aster ericoides	HEATH ASTER
	Eupatorium maculatum	JOE-PYE WEED
	Liatris spicata	DENSE BLAZING STAR
	Monarda fistulosa	WILD BERGAMOT
	Oenothera biennis	EVENING PRIMROSE

UPLAND MEADOW SEED MIX 'B'

Rudbeckia hirta

Vernonia altissima

ABOVE ELEVATION 192.10 TO POND BLOCK LIMIT OF

BLACK-EYED SUSAN

SUBDIVISION

TOTAL AREA INCLUDING MOW ZONE: 3604m2

IRONWEED

% COMPOSITION BOTANICAL NAME COMMON NAME

6 COMPOSITION	BOTANICAL NAME	COMMON NAME
	GRASSES	
30%	Andropogon scoparius	LITTLE BLUESTEM
20%	Elymus canadensis	CANADA WILD RYE
5%	Elymus hystrix	BOTTLEBRUSH GRASS
10%	Bouteloua curtipendula	SIDEOATS GRAMA
15%	Sorghastrum nutans	INDIAN GRASS
	9	
20%	FORBS	
100%	Anemone virginiana	TALL ANEMONE
10070	Aster ericoides	HEATH ASTER
	Aster lateriflorus	CALICO ASTER
	Aster novae-angliae	NEW ENGLAND ASTER
	Lespedeza capitata	ROUND HEADED BUSHCLOVER
	Rudbeckia hirta	BLACK-EYED SUSAN
	Siphilium laciniatum	COMPASS PLANT
	Solidago flexicaulis	ZIG ZAG GOLDENROD
	Solidago juncea	EARLY GOLDENROD
	Solidago patula	ROUGH-LEAVED GOLDENROD
	Solidago rugosa	ROUGH GOLDENROD
	Verbena stricta	HOARY VERVAIN
	the state of the s	ID ON WATER

TOWN OF MILTON SITE---DERRY RD. E KEY MAP

LEGEND:

_ _ _ DEVELOPABLE LIMIT LINE NORMAL WATER LIMIT - 189.00

SPILLWAY ELEV. - 192.10 EXTENDED DETENTION WATER LIMIT - 190.00

PROPOSED POND CONTOUR ELEVATION


SPILLWAYS

BANK STABILIZATION SEED MIX 'A'

UPLAND MEADOW SEED MIX 'B'

R0 ISSUED FOR FIRST SUBMISSION

THESE DRAWINGS ARE THE PROPERTY OF CGLA CONSULTANTS INC. AND SHALL NOT BE ALTERED, MODIFIED, REVISED OR CHANGED WITHOUT THE WRITTEN CONSENT OF CGLA CONSULTANTS INC. SEAL IS NOT VALID WITHOUT SIGNATURE OF THE LANDSCAPE ARCHITECT. DRAWINGS CANNOT BE USED FOR TENDER/CONSTRUCTION UNTIL SIGNED BY LANDSCAPE ARCHITECT.

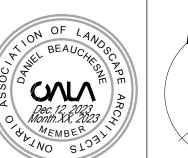



30 CENTURIAN DRIVE, UNIT 105 MARKHAM, ONTARIO, L3R 8B8 Telephone: 905-475-6988 Email info@cgla.ca www.cgla.ca

FRONTENAC FOREST ESTATES INC.

Project Title: FRONTENAC FOREST TOWN OF MILTON

Drawing Title: SWM POND RESTORATION SEEDING PLAN

Drawn: CJ Reviewed: DB Scale: 1:500 Date: 20250303

Project Number: 2813


Drawing Number SWMP_2

GENERAL NOTES:

1. THIS PLAN TO BE USED FOR STORMWATER MANAGEMENT POND NO.1 PLANTING WORKS ONLY.

2. BASE INFORMATION OBTAINED FROM FRONTENAC FOREST ESTATES INC. 3. LANDSCAPE CONTRACTOR SHALL PROVIDE LANDSCAPE

ARCHITECT 48 HOURS NOTICE PRIOR TO COMMENCEMENT. 4. REFER TO DWGS SWM-2, SWM-4 FOR SEEDING PLAN, SWM-5 NOTES AND PLANT LIST, AND D1 FOR DETAILS.

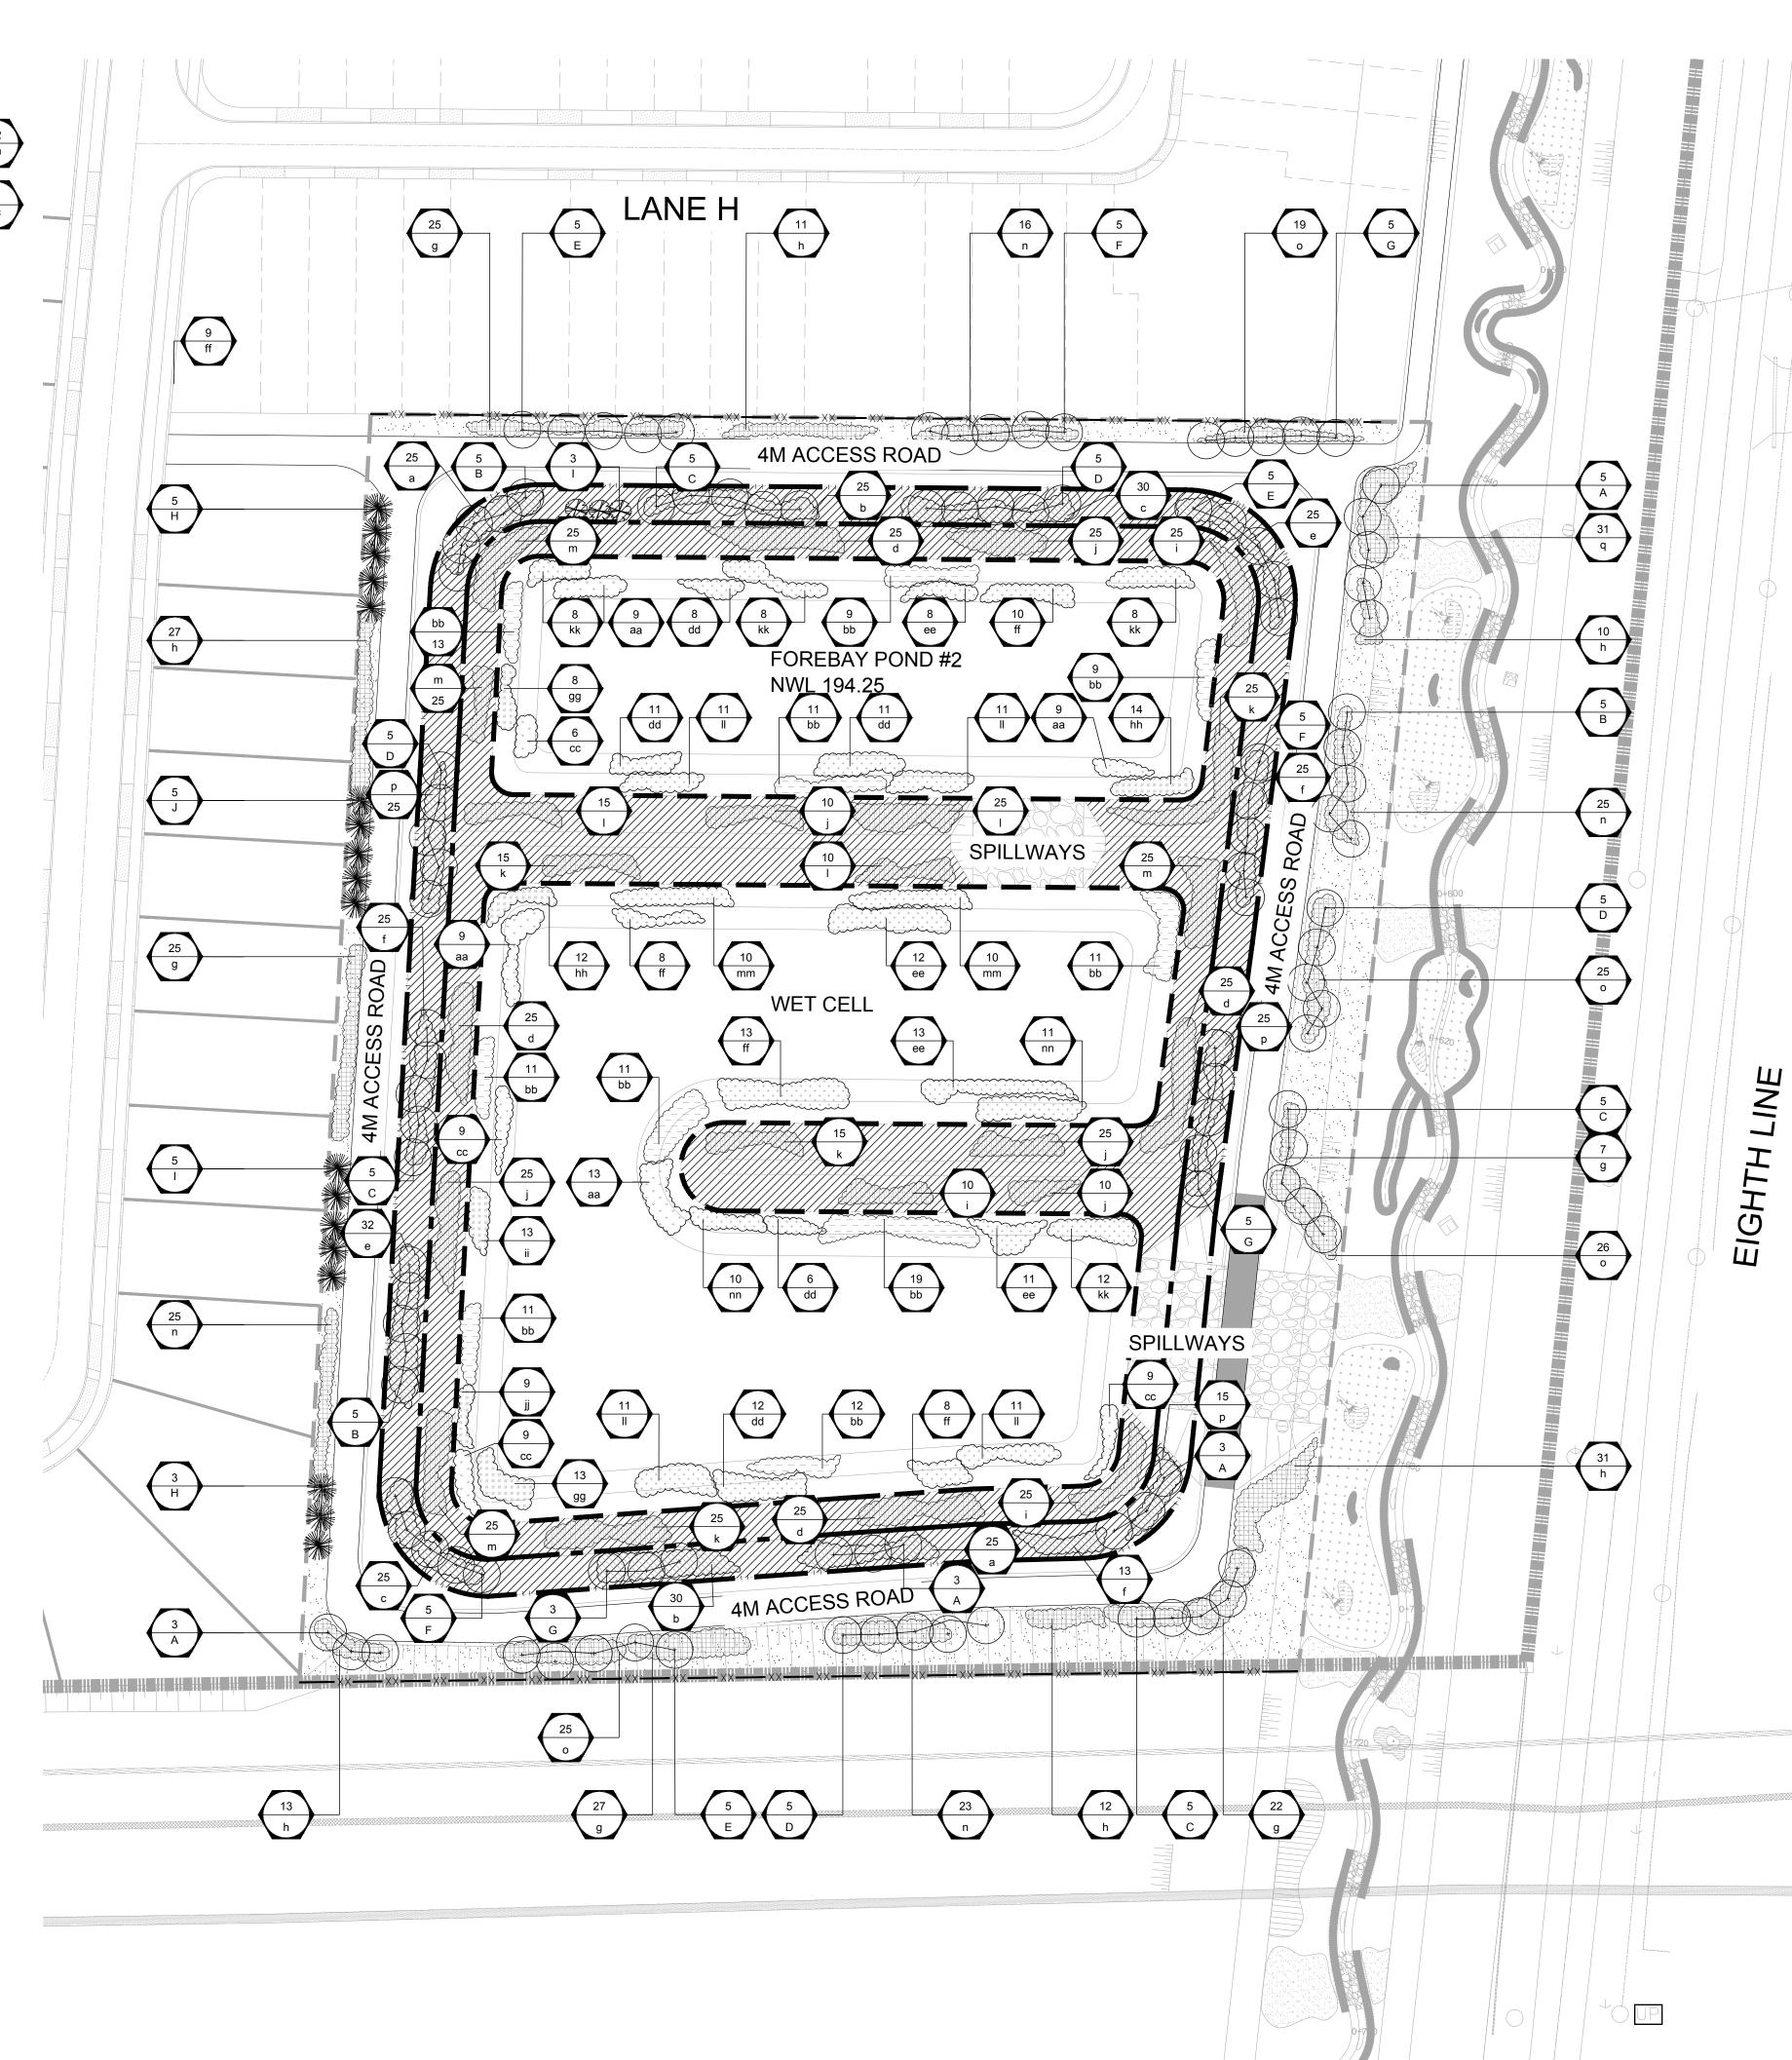

MASTER PLANT LIST

L BOTANICAL NAME	COMMON NAME	HEIGHT	SPREAD CALIPER	COND.	REMARKS
S TREES		(mm)	(mm) (mm)		
ACER SACCHARINUM	SILVER MAPLE	1500-3000	30-60	В&В	
FRAXINUS PENNSYLVANICA	GREEN ASH	1500-3000	30-60	B&B	
PINUS STROBUS	WHITE PINE	1500-3000	30-60	B&B	
POPULUS DELTOIDES	EASTERN COTTONWOOD	1500-3000	30-60	B&B	
QUERCUS ALBA	WHITE OAK	1500-3000	30-60	B&B	
QUERCUS BICOLOR	SWAMP WHITE OAK	1500-3000	30-60	B&B	
SALIX NIGRA	BLACK WILLOW	1500-3000	30-60	B&B	
	S TREES ACER SACCHARINUM FRAXINUS PENNSYLVANICA PINUS STROBUS POPULUS DELTOIDES QUERCUS ALBA QUERCUS BICOLOR	ACER SACCHARINUM SILVER MAPLE FRAXINUS PENNSYLVANICA GREEN ASH PINUS STROBUS WHITE PINE POPULUS DELTOIDES EASTERN COTTONWOOD QUERCUS ALBA WHITE OAK QUERCUS BICOLOR SWAMP WHITE OAK	ACER SACCHARINUM SILVER MAPLE 1500-3000 FRAXINUS PENNSYLVANICA GREEN ASH 1500-3000 PINUS STROBUS WHITE PINE 1500-3000 POPULUS DELTOIDES EASTERN COTTONWOOD 1500-3000 QUERCUS ALBA WHITE OAK 1500-3000 QUERCUS BICOLOR SWAMP WHITE OAK 1500-3000	(mm) (mm) (mm) (mm)	(mm) (mm) (mm) (mm)

TOTAL DECIDUOUS TREES: 112

CONIFEROUS TREES	

MILEK	OUS TREES					
8	PICEA GLAUCA	WHITE SPRUCE	1500-2500	30-50	B&B	
8	PINUS STROBUS	EASTERN WHITE PINE	2000-3000	30-60	B&B	
5	THUJA OCCIDENTALIS	EASTERN WHITE CEDAR	1500-2500	30-50	B&B	

TOTAL CONIFEROUS TREES: 21

KEY	′∣ TOTAL	BOTANICAL NAME	COMMON NAME	HEIGHT SPREAD
SHE	RUBS			(mm)
а	50	AMELANCHIER ARBOREA	DOWNY JUNEBERRY	600
b	55	AMELANCHIER LAEVIS WIEGAND	SMOOTH JUNEBERRY	600
С	55	CEPHALANTHUS OCCIDENTALIS	BUTTONBUSH	600
d	100	CORNUS STOLONIFERA	RED-OSIER DOGWOOD	600
е	57	DIERVILLA LONICERA	BUSH HONEYSUCKLE	600
f	63	ILEX VERTICILLATA	WINTERBERRY	600
g	106	RHUS TYPHINA	STAGHORN SUMAC	600
h	104	RIBES AMERICANUM	WILD BLACK CURRANT	600
i	85	RUBUS ALLEGHENIENSIS	COMMON BLACKBERRY	600
j	75	SALIX ERIOCEPHALA	HEART-LEAVED WILLOW	600
k	80	SALIX LUCIDA	SHINING WILLOW	600
1	75	SAMBUCUS RACEMOSA SSP 'PUBENS'	RED-BERRIED ELDER	600
m	100	SAMBUCUS CANADENSIS	COMMON ELDER	600
n	89	SHEPHERDIA CANADENSIS	SOAPBERRY	600
0	95	VIBURNUM ACERIFOLIUM	MAPLE-LEAVED VIBURNUM	600
р	65	VIBURNUM LENTAGO	NANNYBERRY	600

TOTAL SHRUBS: 1254

	TOTA	AL BOTANICAL NAME	COMMON NAME	HEIGHT	SPREAD
GF	ROUNDO	OVER		(mm)	
q	31	EUONYMUS OBOVATA	RUNNING STRAWBERRY-BUSH	600	

TOTAL GROUNDCOVER: 31

KEY	TOTAL	L BOTANICAL NAME C	OMMON NAME	HEIGHT	ZONE	C0
ZONE	ONE: D	DEEP WATER ZONE				
aa	40	ELODEA CANADENSIS	WATERWEED	100 min	SUB	РО
bb	117	NYMPHAEA ODORATA	FRAGRANT WATER-LILY	100 min	FL	PC
СС	33	POTAMOGETON PECTINATUS	SAGO PONDWEED	100 min	SUB	PO
dd	49	RUDBECKIA HIRTA	BLACK-EYED SUSAN	100 min		PO
ee	44	SAGITTARIA LATIFOLIA	COMMON ARROWHEAD	100 min		PO
ff	39	TYPHA LATIFOLIA	COMMON CATTAIL	100 min		PC
TOTA ZONE		AQUATIC ZONE				
		AQUATIC ZONE				
	TWO: <i>A</i>	AQUATIC ZONE ALISMA PLANTAGO-AQUATICA	WATER-PLANTAIN	100 min	EM	Р
ZONE 99 hh	TWO: <i>A</i>	ALISMA PLANTAGO-AQUATICA CAREX BEBBII	BEBB'S SEDGE	100 min	EM	P
ZONE 99 hh ii	TWO: <i>A</i> 21 26 13	ALISMA PLANTAGO-AQUATICA CAREX BEBBII CAREX HYSTERICINA	BEBB'S SEDGE PORCUPINE SEDGE	100 min 150 min	EM EM	P P
ZONE gg hh ii jj	TWO: A 21 26 13 9	ALISMA PLANTAGO-AQUATICA CAREX BEBBII	BEBB'S SEDGE	100 min	EM EM	P P
ZONE 99 hh ii	TWO: <i>A</i> 21 26 13	ALISMA PLANTAGO-AQUATICA CAREX BEBBII CAREX HYSTERICINA	BEBB'S SEDGE PORCUPINE SEDGE	100 min 150 min	EM EM	P
ZONE gg hh ii jj	TWO: A 21 26 13 9	ALISMA PLANTAGO-AQUATICA CAREX BEBBII CAREX HYSTERICINA CAREX VULPINOIDEA	BEBB'S SEDGE PORCUPINE SEDGE FOX SEDGE	100 min 150 min 150 min	EM EM	P P
ZONE 99 hh ii jj kk	21 26 13 9 36	ALISMA PLANTAGO-AQUATICA CAREX BEBBII CAREX HYSTERICINA CAREX VULPINOIDEA JUNCUS DUDLEYI	BEBB'S SEDGE PORCUPINE SEDGE FOX SEDGE DUDLEY'S RUSH	100 min 150 min 150 min 150 min	EM EM	P P P

1. BARE ROOT PLANTING STOCK WILL BE SUBSTITUTED WITH POTTED MATERIAL IF THE PLANTING TAKES PLACE OUTSIDE THE BARE ROOT SEASON. 2. CONTRACTOR SHALL CONFIRM THAT ALL QUANTITIES SHOWN ON THE PLANT LIST CONFORM WITH THE PLANS.
THE QUANTITIES SHOWN ON THE PLAN SUPERSEDE THE TOTALS OF THE LIST. REPORT ANY DISCREPANCIES TO THE LANDSCAPE ARCHITECT.

GENERAL NOTES:

1. THIS PLAN TO BE USED FOR STORMWATER MANAGEMENT POND NO.2 PLANTING WORKS ONLY.

NOTES AND PLANT LIST, AND D1 FOR DETAILS.


- 2. BASE INFORMATION OBTAINED FROM FRONTENAC FOREST ESTATES INC.
- 3. LANDSCAPE CONTRACTOR SHALL PROVIDE LANDSCAPE ARCHITECT 48 HOURS NOTICE PRIOR TO COMMENCEMENT. 4. REFER TO DWGS SWM-2, SWM-4 FOR SEEDING PLAN, SWM-5

TOWN OF MILTON KEY MAP

LEGEND: _ _ _ DEVELOPABLE LIMIT LINE NORMAL WATER LIMIT - 194.25 SPILLWAY ELEV. - 196.05

EXTENDED DETENTION WATER LIMIT - 195.25 PROPOSED POND CONTOUR ELEVATION

—xx—xx— 1.8m HIGH CHAIN LINK FENCE

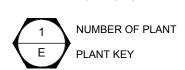

PROPOSED EMERGENT AQUATICS PROPOSED FLOATING AQUATICS

PROPOSED AQUATICS

SUBMERGENT AQUATICS PROPOSED SHORELINE FRINGE CONTINUOUS MULCH SHRUB BED

PROPOSED FLOOD FRINGE CONTINUOUS MULCH SHRUB BED

PROPOSED UPLAND CONTINUOUS MULCH SHRUB BED

SPILLWAYS

BANK STABILIZATION SEED MIX 'A'

: UPLAND MEADOW SEED MIX 'B'

R0 ISSUED FOR FIRST SUBMISSION

THESE DRAWINGS ARE THE PROPERTY OF CGLA CONSULTANTS INC. AND SHALL NOT BE ALTERED, MODIFIED, REVISED OR CHANGED WITHOUT THE WRITTEN CONSENT OF CGLA CONSULTANTS INC. SEAL IS NOT VALID WITHOUT SIGNATURE OF THE LANDSCAPE ARCHITECT. DRAWINGS CANNOT BE USED FOR TENDER/CONSTRUCTION UNTIL SIGNED BY LANDSCAPE ARCHITECT.





30 CENTURIAN DRIVE, UNIT 105 MARKHAM, ONTARIO, L3R 8B8 Telephone: 905-475-6988 Email info@cgla.ca www.cgla.ca


FRONTENAC FOREST ESTATES INC.

Project Title: FRONTENAC FOREST TOWN OF MILTON

Drawing Title: SWM POND RESTORATION LANDSCAPE PLAN

Reviewed:	DB	Drawn	: CJ
Scale:	1:500	Date:	20250303
Project Num	nber:	2813	

Drawing Number SWMP_3

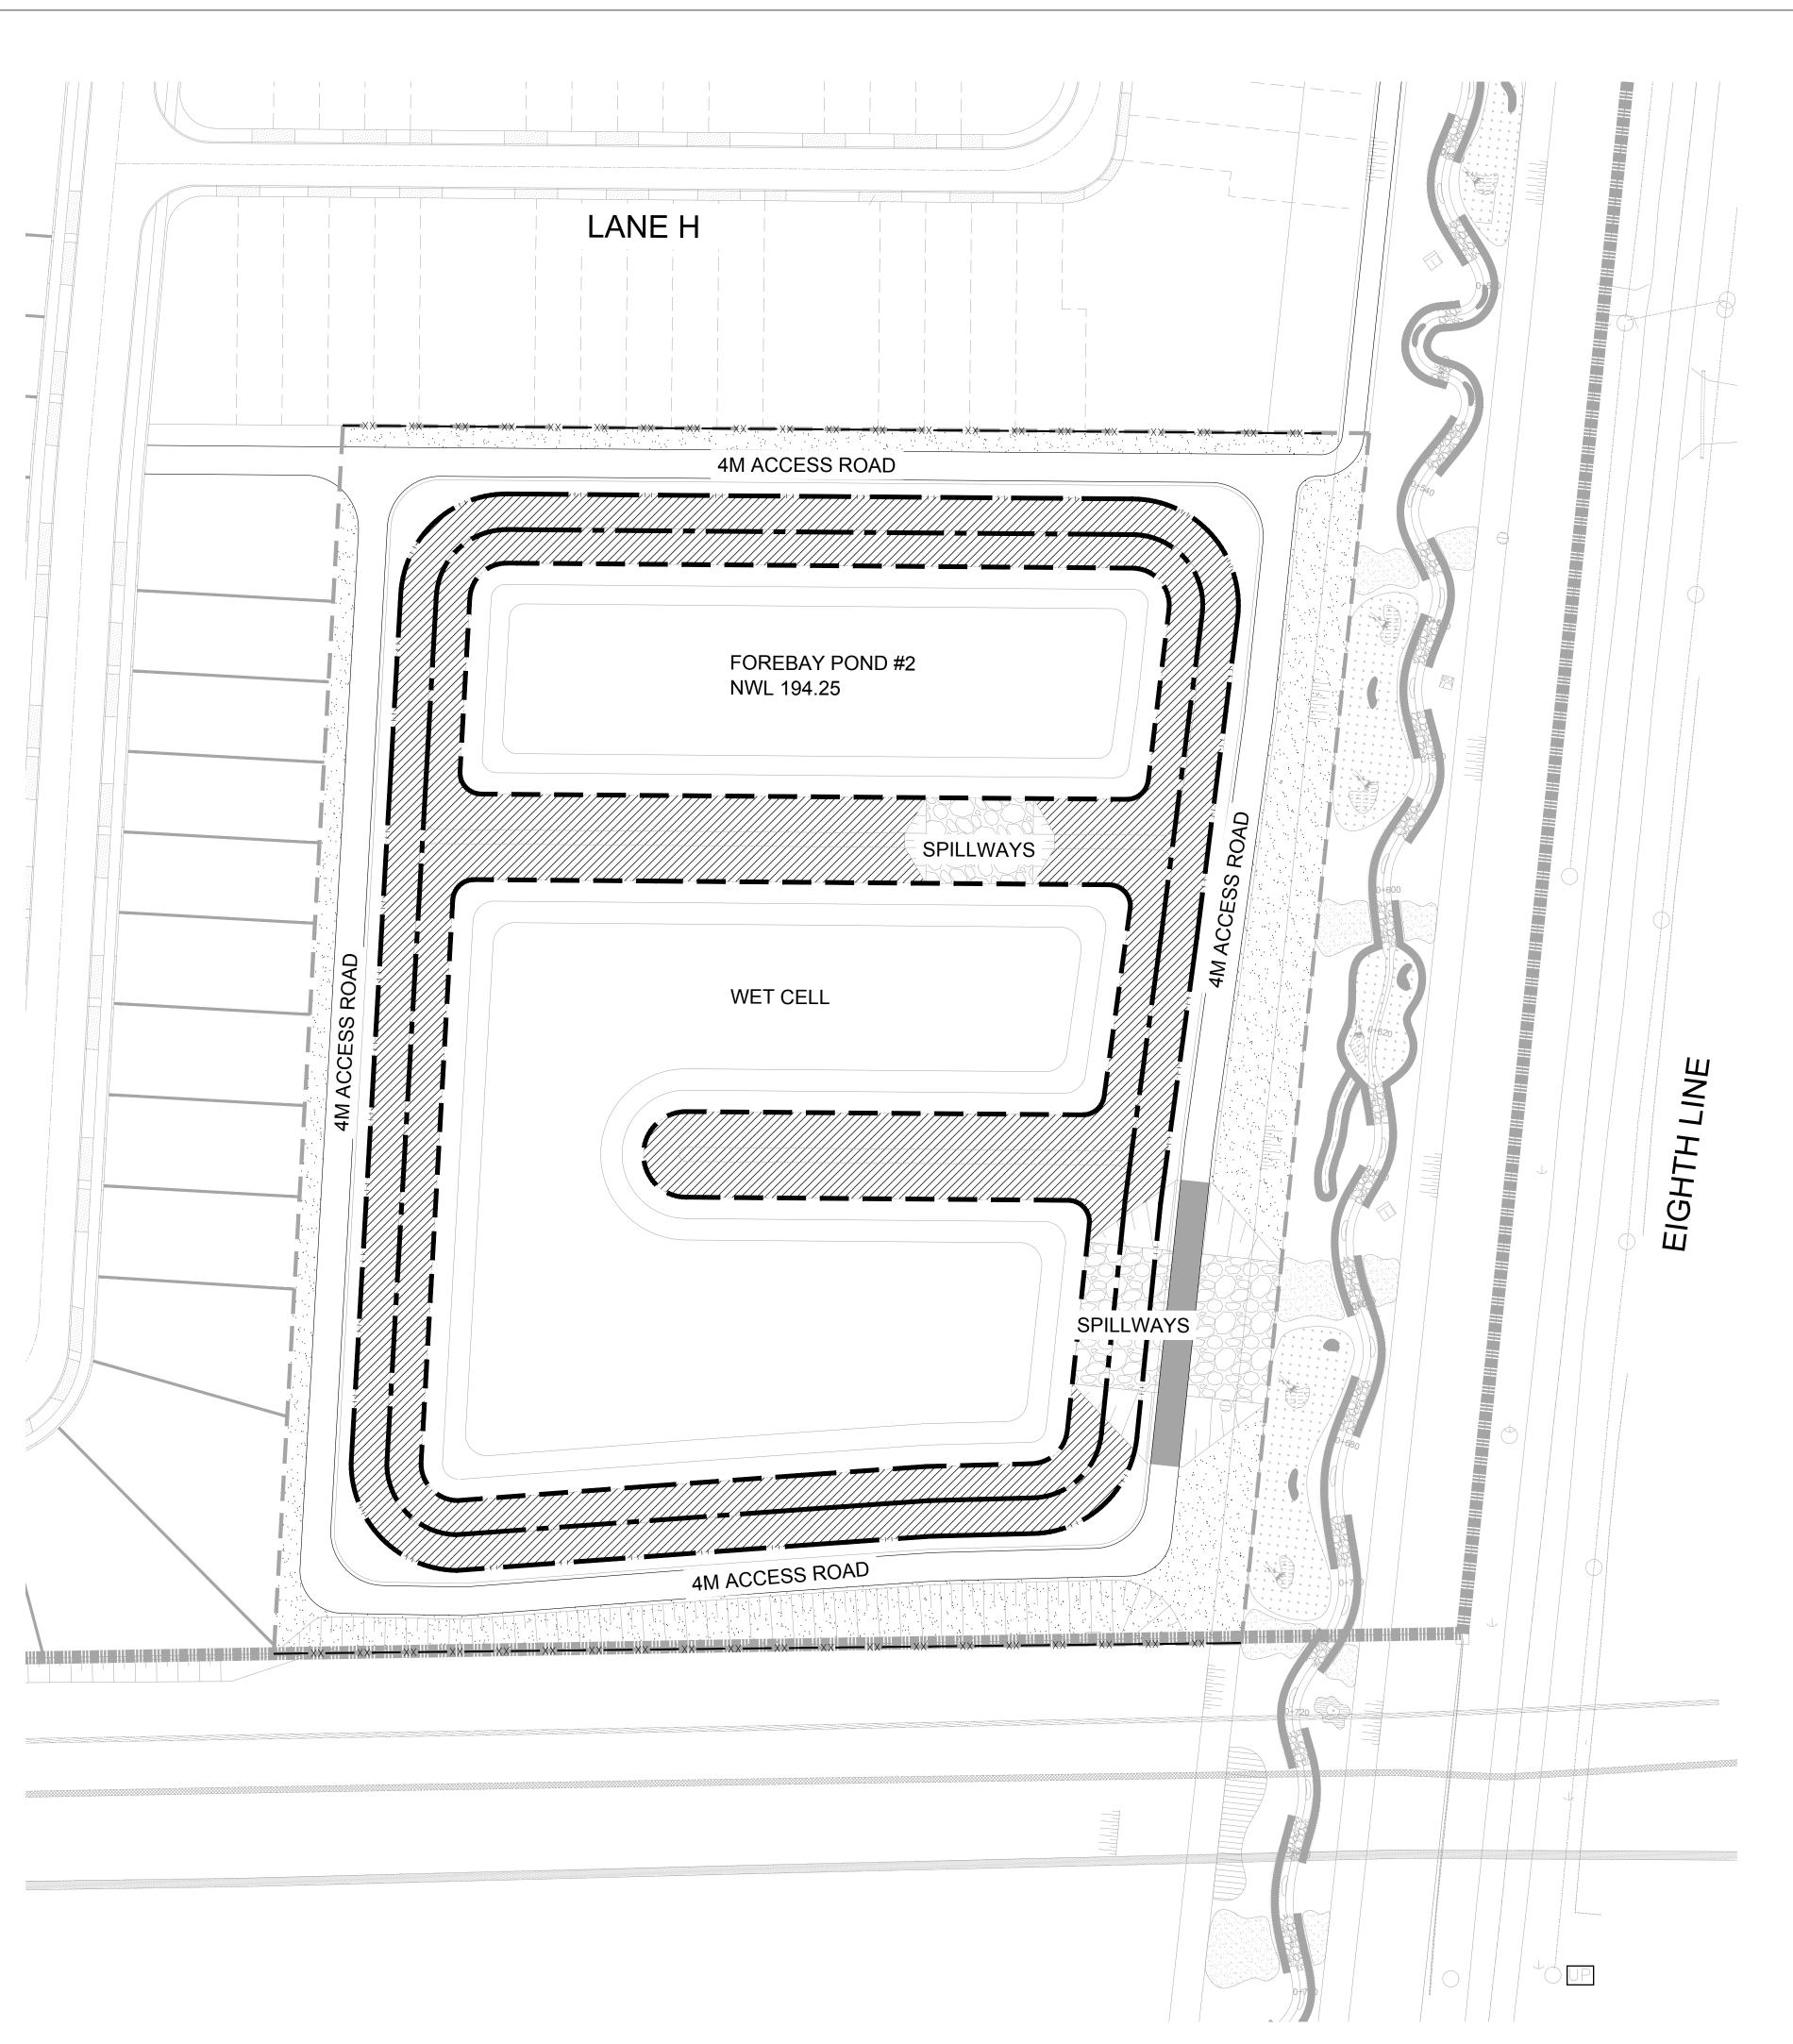

SEEDING NOTES:

SEED SHALL BE A PNEUMATICALLY APPLIED MIXTURE OF COMPOSTED ORGANICS PROVIDED BY LANDSOURCE ORGANICS LTD. (TERRASEEDING) OR APPROVED EQUAL APPLIED TO DEPTH OF 50mm. DO NOT FERTILIZE. SEEDING. ALL SEEDING SHALL BE COMPLETED MAY 15 - JUNE 30 OR SEPTEMBER 1 - SEPTEMBER 21. COVER CROP: ANNUAL OATS (Avena sativa) TO BE APPLIED IN ANY SEASON IF NECESSARY.

1ST GROWING SEASON - DO NOT CUT

2ND GROWING SEASON

- WATER BI-WEEKLY UNTIL ONSET OF FROST WITH SUFFICIENT AMOUNTS TO ENSURE GERMINATION

- WEED REMOVAL BY HAND AS NECESSARY - ONCE SWARD HAS REACHED 100mm CUT BY HAND

AT 50mm HEIGHT. ENSURE CUTTINGS ARE EJECTED AWAY FROM OPEN WATER - CUT TO A HEIGHT OF 300mm IN MID-SUMMER, ONCE

BIENNIAL WEEDS SUCH AS SWEET CLOVER ARE IN FULL BLOOM

- CUT AGAIN IN OCTOBER TO A HEIGHT OF 150-300mm

3RD AND ALTERNATING - ONCE SWARD HAS REACHED A HEIGHT OF 100mm, **GROWING SEASONS** CUT BY HAND TO 50mm HEIGHT

OPTIONAL TEMPORARY SEEDING (POND)

NOTE: ALL PROPOSED TOPSOIL AND SEEDED AREAS TO BE TEMPORARILY STABILIZED WITH ANNUAL OATS (AVENA SATIVA) TO BE APPLIED BY HAND, IN ANY SEASON. - SEEDING RATE 35KG/HA. SHOULD FINAL PLANTING NOT PROCEED FOLLOWING ONE GROWING SEASON AREA TO BE RE-STABILIZED WITH ANNUAL OATS.

	<u>/////</u>	ELEVATION 194.25 TOTAL AREA: 5972m2
% COMPOSITION	BOTANICAL NAME	COMMON NAME
	GRASSES	
20%	Andropogon gerardii	BIG BLUESTEM
15%	Calamagrostis canadensis	CANADA BLUE JOINT
10%	Elymus canadensis	CANADA WILD RYE
15%	Glyceria striata	FOWL MANNA GRASS
15%	Panicum virgatum	SWITCH GRASS
10%	Sorghastrum nutans	INDIAN GRASS
15%	FORBS	
100%	Asclepias incarnata	SWAMP MILKWEED
	Aster ericoides	HEATH ASTER
	Eupatorium maculatum	JOE-PYE WEED
	Liatris spicata	DENSE BLAZING STAR
	Monarda fistulosa	WILD BERGAMOT
	Oenothera biennis	EVENING PRIMROSE

BANK STABILIZATION SEED MIX 'A' TO NORMAL WATER LEVEL

UPLAND MEADOW SEED MIX 'B'

Rudbeckia hirta

ABOVE ELEVATION 196.35 TO POND BLOCK LIMIT OF SUBDIVISION TOTAL AREA INCLUDING MOW ZONE: 3211m2

BLACK-EYED SUSAN

% COMPOSITION BOTANICAL NAME COMMON NAME


	GRASSES	
30%	Andropogon scoparius	LITTLE BLUESTEM
20%	Elymus canadensis	CANADA WILD RYE
5%	Elymus hystrix	BOTTLEBRUSH GRASS
10%	Bouteloua curtipendula	SIDEOATS GRAMA
15%	Sorghastrum nutans	INDIAN GRASS
20%	FORBS	
100%	Anemone virginiana	TALL ANEMONE
	Aster ericoides	HEATH ASTER
	Aster lateriflorus	CALICO ASTER
	Aster novae-angliae	NEW ENGLAND ASTER
	Lespedeza capitata	ROUND HEADED BUSHCLOVER
	Rudbeckia hirta	BLACK-EYED SUSAN
	Siphilium laciniatum	COMPASS PLANT
	Solidago flexicaulis	ZIG ZAG GOLDENROD
	Solidago juncea	EARLY GOLDENROD
	Solidago patula	ROUGH-LEAVED GOLDENROD
	Solidago rugosa	ROUGH GOLDENROD
	Verbena stricta	HOARY VERVAIN
	Vernonia altissima	IRONWEED

GENERAL NOTES:

- 1. THIS PLAN TO BE USED FOR STORMWATER MANAGEMENT
- POND NO.2 PLANTING WORKS ONLY. 2. BASE INFORMATION OBTAINED FROM FRONTENAC FOREST

NOTES AND PLANT LIST, AND D1 FOR DETAILS.

- ESTATES INC.
- 3. LANDSCAPE CONTRACTOR SHALL PROVIDE LANDSCAPE ARCHITECT 48 HOURS NOTICE PRIOR TO COMMENCEMENT. 4. REFER TO DWGS SWM-2, SWM-4 FOR SEEDING PLAN, SWM-5

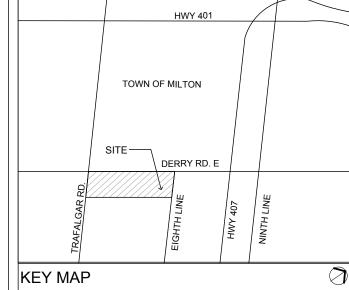

LEGEND:


_ _ _ DEVELOPABLE LIMIT LINE NORMAL WATER LIMIT - 194.25 SPILLWAY ELEV. - 196.05

EXTENDED DETENTION WATER LIMIT - 195.25 PROPOSED POND CONTOUR ELEVATION

SPILLWAYS

BANK STABILIZATION SEED MIX 'A'

UPLAND MEADOW SEED MIX 'B'

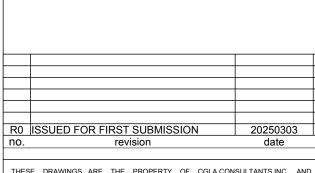

THESE DRAWINGS ARE THE PROPERTY OF CGLA CONSULTANTS INC. AND SHALL NOT BE ALTERED, MODIFIED, REVISED OR CHANGED WITHOUT THE WRITTEN CONSENT OF CGLA CONSULTANTS INC. SEAL IS NOT VALID WITHOUT SIGNATURE OF THE LANDSCAPE ARCHITECT. DRAWINGS CANNOT BE USED FOR TENDER/CONSTRUCTION UNTIL SIGNED BY LANDSCAPE ARCHITECT.





30 CENTURIAN DRIVE, UNIT 105 MARKHAM, ONTARIO, L3R 8B8 Telephone: 905-475-6988 Email info@cgla.ca www.cgla.ca

FRONTENAC FOREST ESTATES INC.

Project Title: FRONTENAC FOREST TOWN OF MILTON

Drawing Title: SWM POND RESTORATION SEEDING PLAN

Reviewed: DB Drawn: CJ Scale: 1:500 Date: 20250303

Project Number: 2813

Drawing Number SWMP_4

POND MAINTENANCE PROGRAM (2 YEAR)

- 1. ALL PLANTINGS SHALL BE WATERED BI-WEEKLY DURING JUNE 15 SEPTEMBER 15 PERIOD AND WEEKLY DURING PERIODS OF DROUGHT (ANY PERIOD OVER 3 WEEKS WITHOUT RAIN).
- 2. EARLY SPRING AND FALL VEGETATION MANAGEMENT SHALL INCLUDE THE FOLLOWING TASKS:
- WEED CUTTING AND REMOVAL BY HAND TRIMMER AND DISPOSAL OFF SITE
- PRUNING ALL DEAD, DISEASED OR DAMAGED MATERIAL FROM ALL TREES AND SHRUBS
 DISPOSAL OF ALL MAN-MADE DEBRIS OFF SITE
- ADDITION OF FOrces DEED CUDEDDED DADK MULCULTO ALL DEDG AND TD
- ADDITION OF 50mm DEEP SHREDDED BARK MULCH TO ALL BEDS AND TREE PITS
 INVASIVE ALIEN SPECIES FOUND GROWING WITHIN POND RESTORATION ZONE SHALL BE REMOVED
- FULLY IN SPRING AND FALL EACH YEAR BY HAND AND DISPOSED OF OFF SITE. INVASIVE ALIEN SPECIES
- TO BE REMOVED INCLUDE THE FOLLOWING:
- Rhamnus cathartica COMMON BUCKTHORN
- Acer platanoides NORWAY MAPLE Alliaria petiolata - GARLIC MUSTARD
- Cynanchum rossicum DOG STRANGLING VINE
- Acer negundo MANITOBA MAPLE
- 4. MONITOR PERFORMANCE OF ALL PLANTING INCLUDING SEEDING AND EROSION CONTROL MEASURES.

POND REHABILITATION SEED MIXTURE

- 1. SEED AT A RATE OF 20kg/Ha. INOCULATE WITH RHIZOBIA. SEED ON A WELL WORKED SEED BED DO NOT FERTILIZE. SEEDING SHALL BE COMPLETED DURING EARLY SPRING OR FALL (MAY 15-30 OR SEPTEMBER 1-21).
- SEEDING SHALL BE COMPLETED WITH THE FOLLOWING METHOD:
 A FRESH OR STRATIFIED SEED WILL BE APPLIED WITH CLEAN, WEED FREE
 COMPOST USING PNEUMATIC BLOWN IN COMPOST METHOD ('TERRASEED' OR APPROVED
 EQUAL).
- PLANTING AT A DEPTH OF 50mm MINIMUM, INCLUDING ACCESS ROAD AND TURFSTONE SURFACES.

3. TERRASEEDING SHALL BE COMPLETED CONCURRENTLY OR IMMEDIATELY AFTER

4. ALL AREAS DISTURBED BY POND SILT CLEAN OUT SHALL BE RE-SEEDED USING APPROVED NATIVE SEED MIXTURE.

RESTORATION PLANTING NOTES:

- 1. ALL PLANT MATERIAL SHALL BE MAINTAINED BY THE CONTRACTOR IMMEDIATELY
- FOLLOWING PLANTING UNTIL THE DATE OF ACCEPTANCE.

 2. MAINTENANCE SHALL INCLUDE ALL MEASURES NECESSARY TO ESTABLISH AND MAINTAIN
- ALL PLANTS IN AN ACCEPTABLE, VIGOROUS AND HEALTHY CONDITION INCLUDING CULTIVATING AND WEEDING, WATERING WHEN REQUIRED, PRUNING AND MAINTENANCE OS ALL ACCESSORIES.
- 3. ALL PLANT MATERIALS SHALL BE GUARANTEED FOR A PERIOD OF 2 (TWO) YEAR UNLESS OTHERWISE NOTED.
- 4. AT TIME OF INSPECTION FOR ACCEPTANCE, ALL PLANTING BEDS AND TREE PITS SHALL BE CULTIVATED, FREE OF WEEDS, BROKEN BRANCHES AND DEBRIS.
- 5. THE CONTRACTOR SHALL BE RESPONSIBLE FOR THE PROTECTION OF ALL TREES AND SHRUBS FROM RODENT AND OTHER DAMAGE FOR THE DURATION OF THE GUARANTEE
- PERIOD.

 PROTECTIVE COLLARS SHALL BE INSTALLED PRIOR TO THE APPLICATION OF SHREDDED
- MULCH. COLLARS SHALL BE FLEXIBLE PLASTIC COMPOSITION, A MINIMUM OF 400mm HIGH AND 100mm IN DIAMETER.
- 6. THE CONTRACTOR SHALL REMOVE ALL T-BAR TREE STAKES PRIOR TO ACCEPTANCE BY THE TOWN OF NEW TECUMSETH.
- 7. ALL AREAS DISTURBED BY CONSTRUCTION ACTIVITY SHALL BE TERRASEEDED WITH SPECIFIED REHABILITATION SEED MIXTURE.
- 8. AQUATIC AND SHORELINE PLANTING TO BE COMPLETED CONCURRENT WITH POND BANK PLANTING. SUBMERGENT AQUATIC PLANTS SHALL BE MATURE POTTED PLANTS PLANTED AT 0.3 TO 0.75 METRE DEPTH. EMERGENT AQUATICS (PLUGS) SHALL PLANTED FROM AQUATIC FRINGE TO 0.3 METRE DEPTH. CATTAILS (TYPHA LATIFOLIA) AND BULRUSHES (SCIRPUS SP) SHALL BE INSTALLED AS INTERIM FILTERING VEGETATION IN SEDIMENT FOREBAYS (TO BE REMOVED AT POND CLEAN OUT PRIOR TO POND ASSUMPTION). THEY WILL RECOLONIZE POST DREDGING.
- 9. THE LANDSCAPE RESTORATION CONTRACTOR SHALL CONTACT THE LANDSCAPE ARCHITECT
- FOR PLANT SPECIES SUBSTITUTION REQUESTS IMMEDIATELY IN ORDER TO REQUEST CONSERVATION HALTON APPROVAL.
- 10. PRIOR TO TOPSOILING THE POND BLOCK CONSULTING ENGINEER STAFF SHALL REVIEW THE SUITABILITY OF SUBSOIL MATERIAL AND LEVEL OF COMPACTION WITH LANDSCAPE
- 11. CONTRACTOR SHALL REMOVE ALL WIRE BASKETS AND BURLAP FROM PLANT MATERIAL UPON PLANTING.
- 12. TOPSOIL DEPTH SHALL BE 450-1000mm FOR ALL AREAS ABOVE THE PERMANENT WATER LEVEL AND 300mm DEPTH MINIMUM FOR THE FIRST 1.0 METRE BELOW THE PERMANENT WATER LEVEL ALONG POND AQUATIC FRINGE.
- 13. SHRUB PLANTING DENSITIES SHALL BE 2m ON CENTRE.
- 14. CONTRACTOR SHALL MINIMIZE DISTURBANCE TO SEEDED AREAS. DAMAGE TO SOILS AND SEEDED AREA (AS DETERMINED BY THE LANDSCAPE ARCHITECT) SHALL BE RESTORED BY THE CONTRACTOR, TO THE LANDSCAPE ARCHITECTS APPROVAL, AT THE CONTRACTORS EXPENSE.
- 15. ANGLE OF REPOSE VARIES WITH STEEP SLOPE AND SOIL CONDITIONS. TAMP TOPSOIL MIX AROUND ROOT SYSTEM IN 150mm THICK LAYERS.
- 16. SCARIFY SURFACE OF SUBSOIL PRIOR TO PLANTING TREES AND SHRUBS.
- 17. ALL PLANTS SHALL BE NURSERY GROWN NATIVE STOCK OF LOCAL PROVENANCE CONSERVATION HALTON LOCAL SEED ZONE 34 UNLESS OTHERWISE SPECIFIED.
- 18. RESTORE ALL DISTURBED AREAS TO ORIGINAL CONDITION AND TO THE SATISFACTION OF THE TOWN OF NEW TECUMSETH.


GENERAL NOTES:

- 1. THIS PLAN TO BE USED FOR STORMWATER MANAGEMENT
- POND NO.1 AND NO. 2 PLANTING WORKS ONLY.
 2. BASE INFORMATION OBTAINED FROM.
- 3. LANDSCAPE CONTRACTOR SHALL PROVIDE LANDSCAPE
- ARCHITECT 48 HOURS NOTICE PRIOR TO COMMENCEMENT.
- 4. REFER TO DWGS SWM-2, SWM-4 FOR SEEDING PLAN, SWM-5 NOTES AND PLANT LIST, AND D1 FOR DETAILS.

RO ISSUED FOR FIRST SUBMISSION 20250303

NO. revision date by

THESE DRAWINGS ARE THE PROPERTY OF CGLA CONSULTANTS INC. AND SHALL NOT BE ALTERED, MODIFIED, REVISED OR CHANGED WITHOUT THE WRITTEN CONSENT OF CGLA CONSULTANTS INC. SEAL IS NOT VALID WITHOUT SIGNATURE OF THE LANDSCAPE ARCHITECT. DRAWINGS CANNOT BE USED FOR TENDER/CONSTRUCTION UNTIL SIGNED BY LANDSCAPE ARCHITECT.

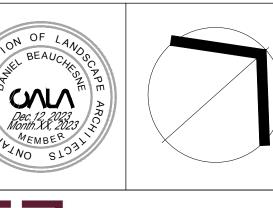

30 CENTURIAN DRIVE, UNIT 105
MARKHAM, ONTARIO, L3R 8B8
Telephone: 905-475-6988 Email info@cgla.ca www.cgla.ca

Clien

FRONTENAC FOREST ESTATES INC.

Project Title:
FRONTENAC FOREST
TOWN OF MILTON

SWM POND
RESTORATION PLAN
LIST AND NOTES

Reviewed: DB Drawn: CJ

Scale: NTS Date: 20250303

2813

Project Number:


SWMP_5








NEIGHBORHOOD PARK 1

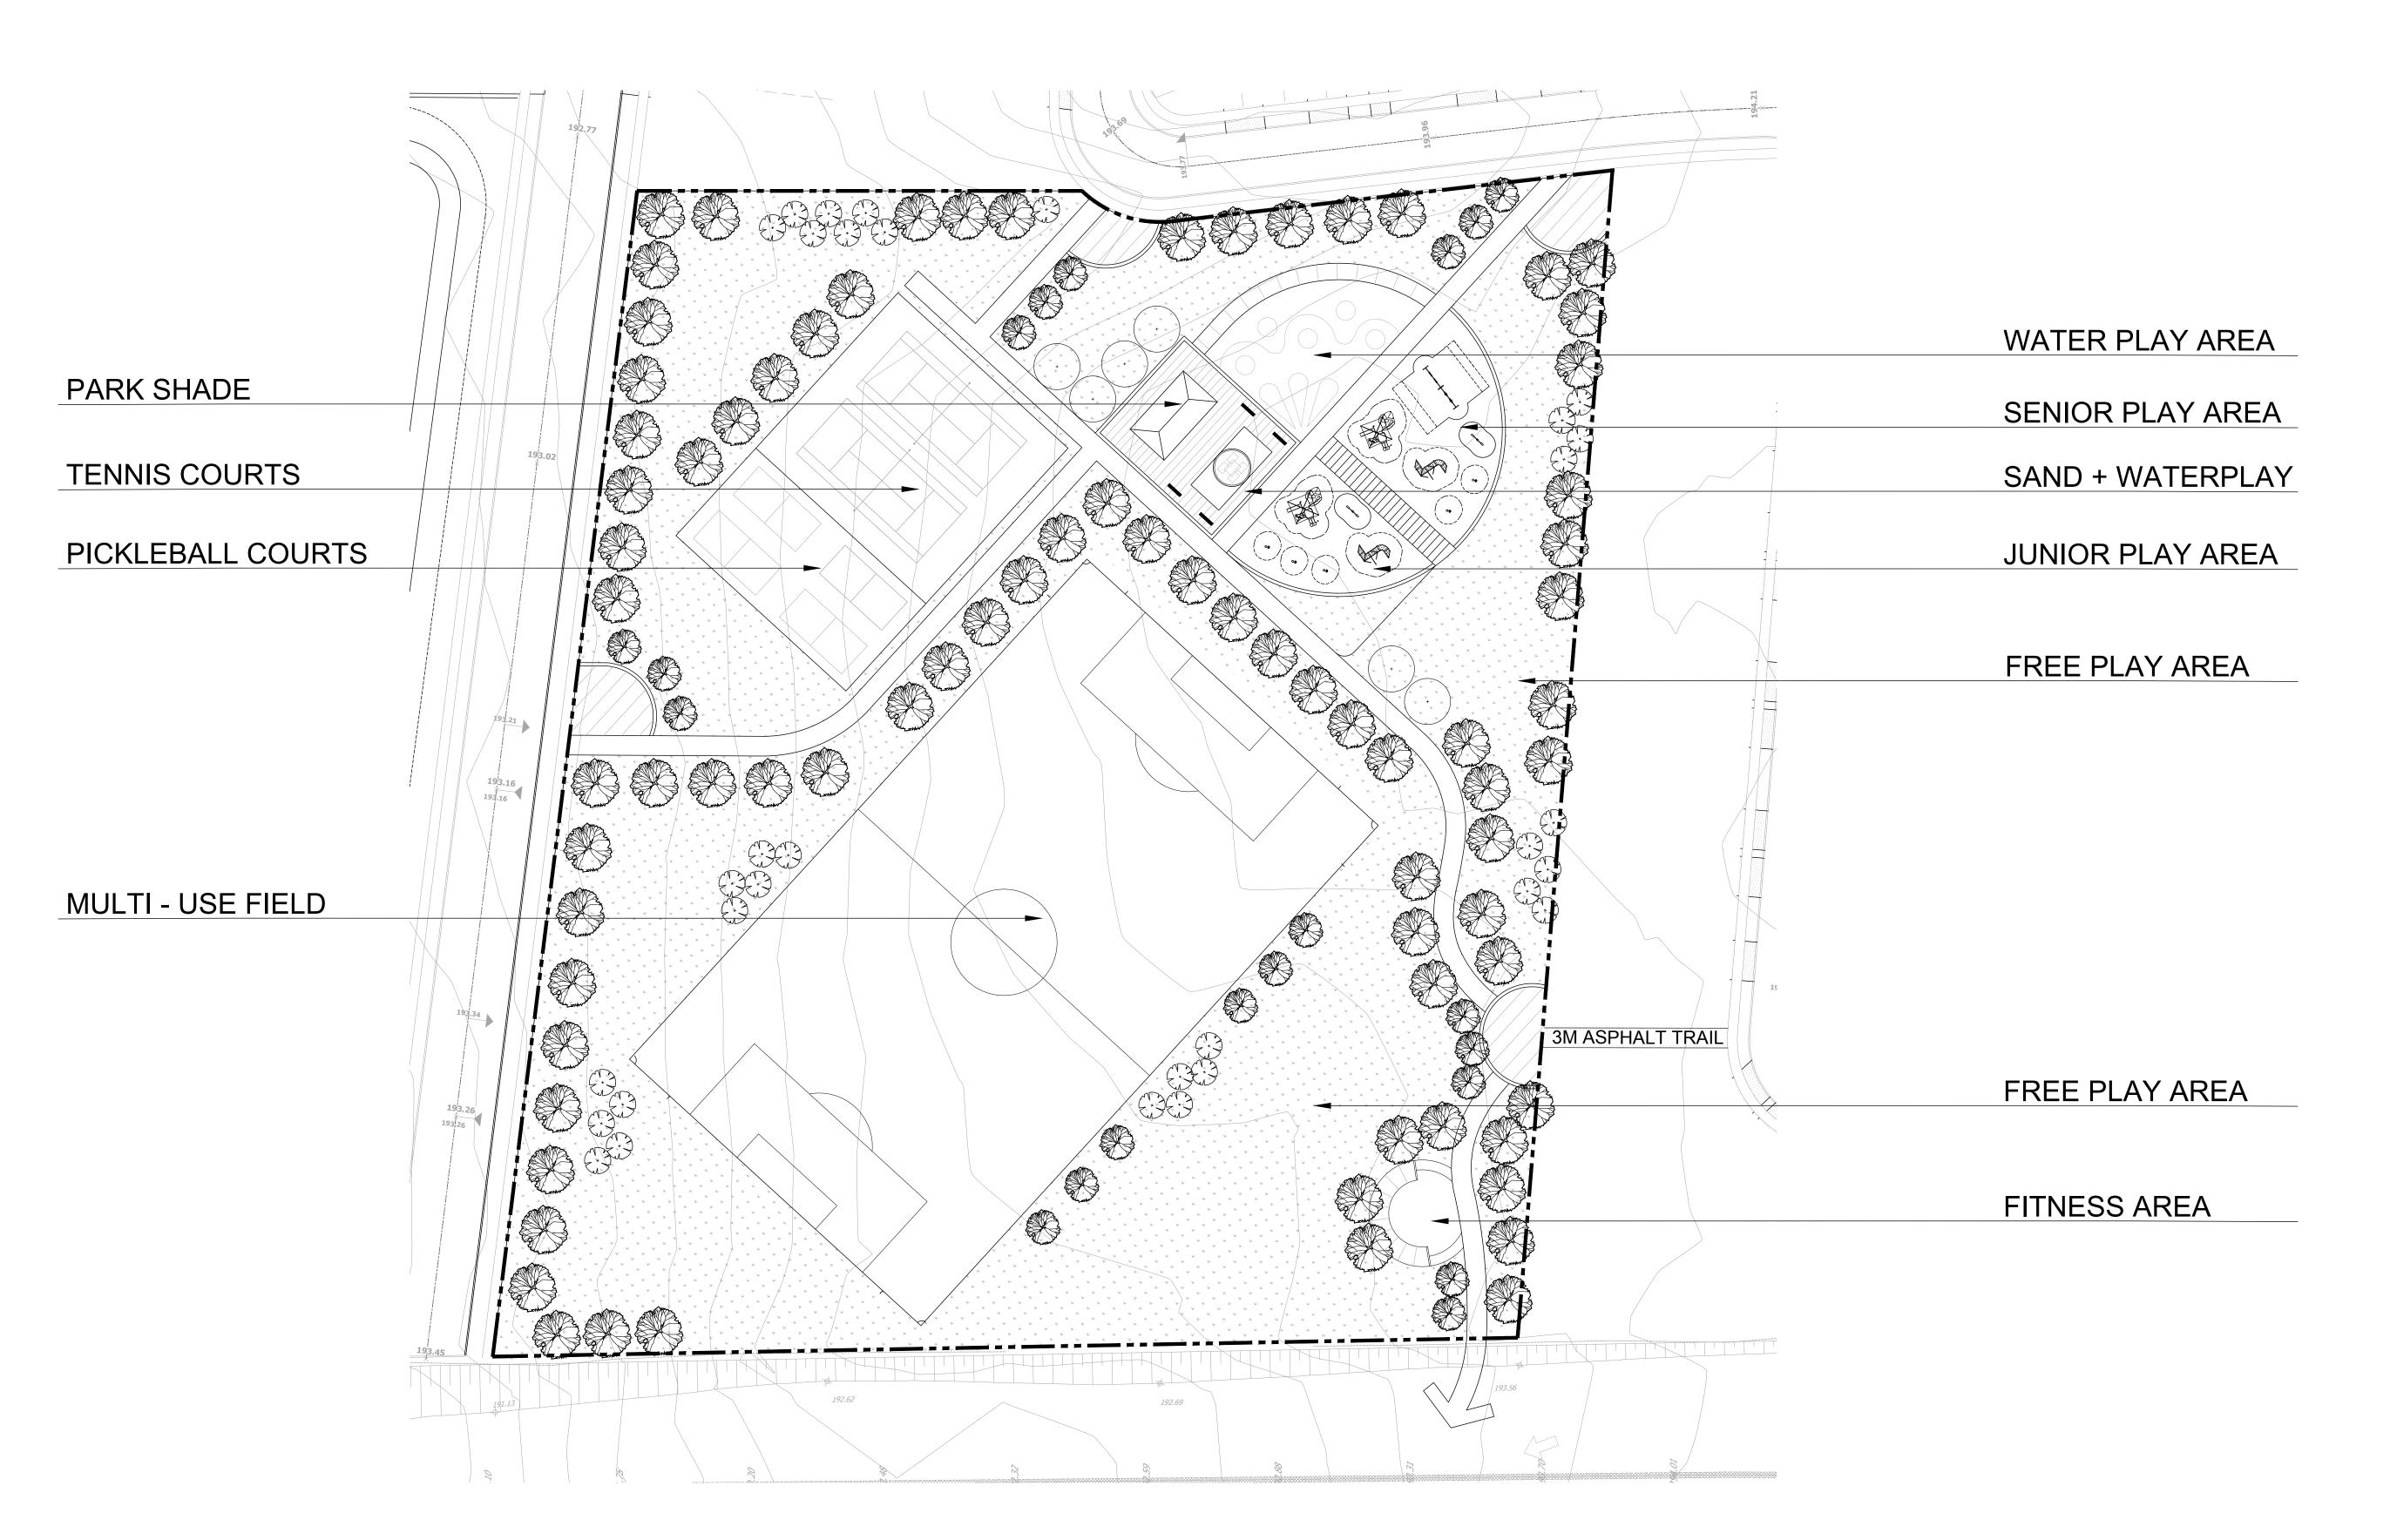

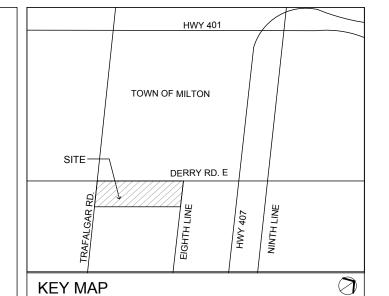


I ECENID:

SODDING

PROPOSED DECIDUOUS TREES

0 ISSUED FOR FIRST SUBMISSION 20250327 Co. revision date

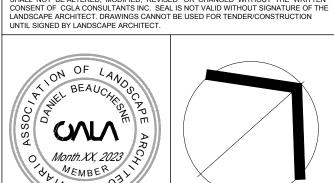



FRONTENAC FOREST ESTATES INC.

TOWN OF MILTON

Project Title:
FRONTENAC FOREST

Drawing Title:
NEIGHBORHOOD
PARK 1
FACILITY FIT

Reviewed: DB Drawn: CJ
Scale: 1:500 Date: 20250327

Project Number:


Drawing Number

ber **F**


P1

NEIGHBORHOOD PARK 2 (OPTION 1)



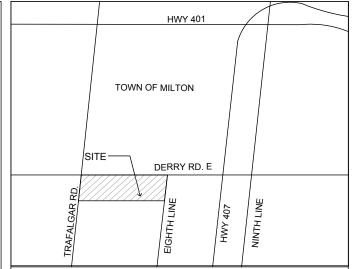

PROPOSED DECIDUOUS TREES

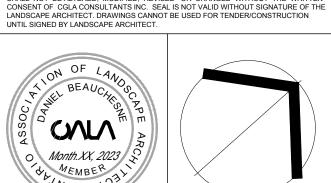



FRONTENAC FOREST ESTATES INC.

TOWN OF MILTON

Project Title: FRONTENAC FOREST

Drawing Title: NEIGHBORHOOD PARK 2 FACILITY FIT


Drawn: CJ 1:500 Date: 20250327

Project Number: **Drawing Number**

P2A

NEIGHBORHOOD PARK 2 (OPTION 2)



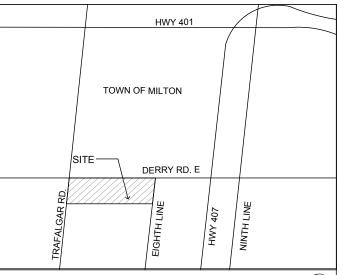

LEOEND.

LIMIT OF SUBDING

PROPOSED DECIDUOUS TRE

20 ISSUED FOR FIRST SUBMISSION 20250327 CO. revision date b





FRONTENAC FOREST ESTATES INC.

TOWN OF MILTON

Project Title:
FRONTENAC FOREST

Drawing Title:
NEIGHBORHOOD
PARK 2
FACILITY FIT


Reviewed: DB Drawn: CJ
Scale: 1:500 Date: 20250327


Project Number:

Drawing Number

P2B

VILLAGE SQUARE 1

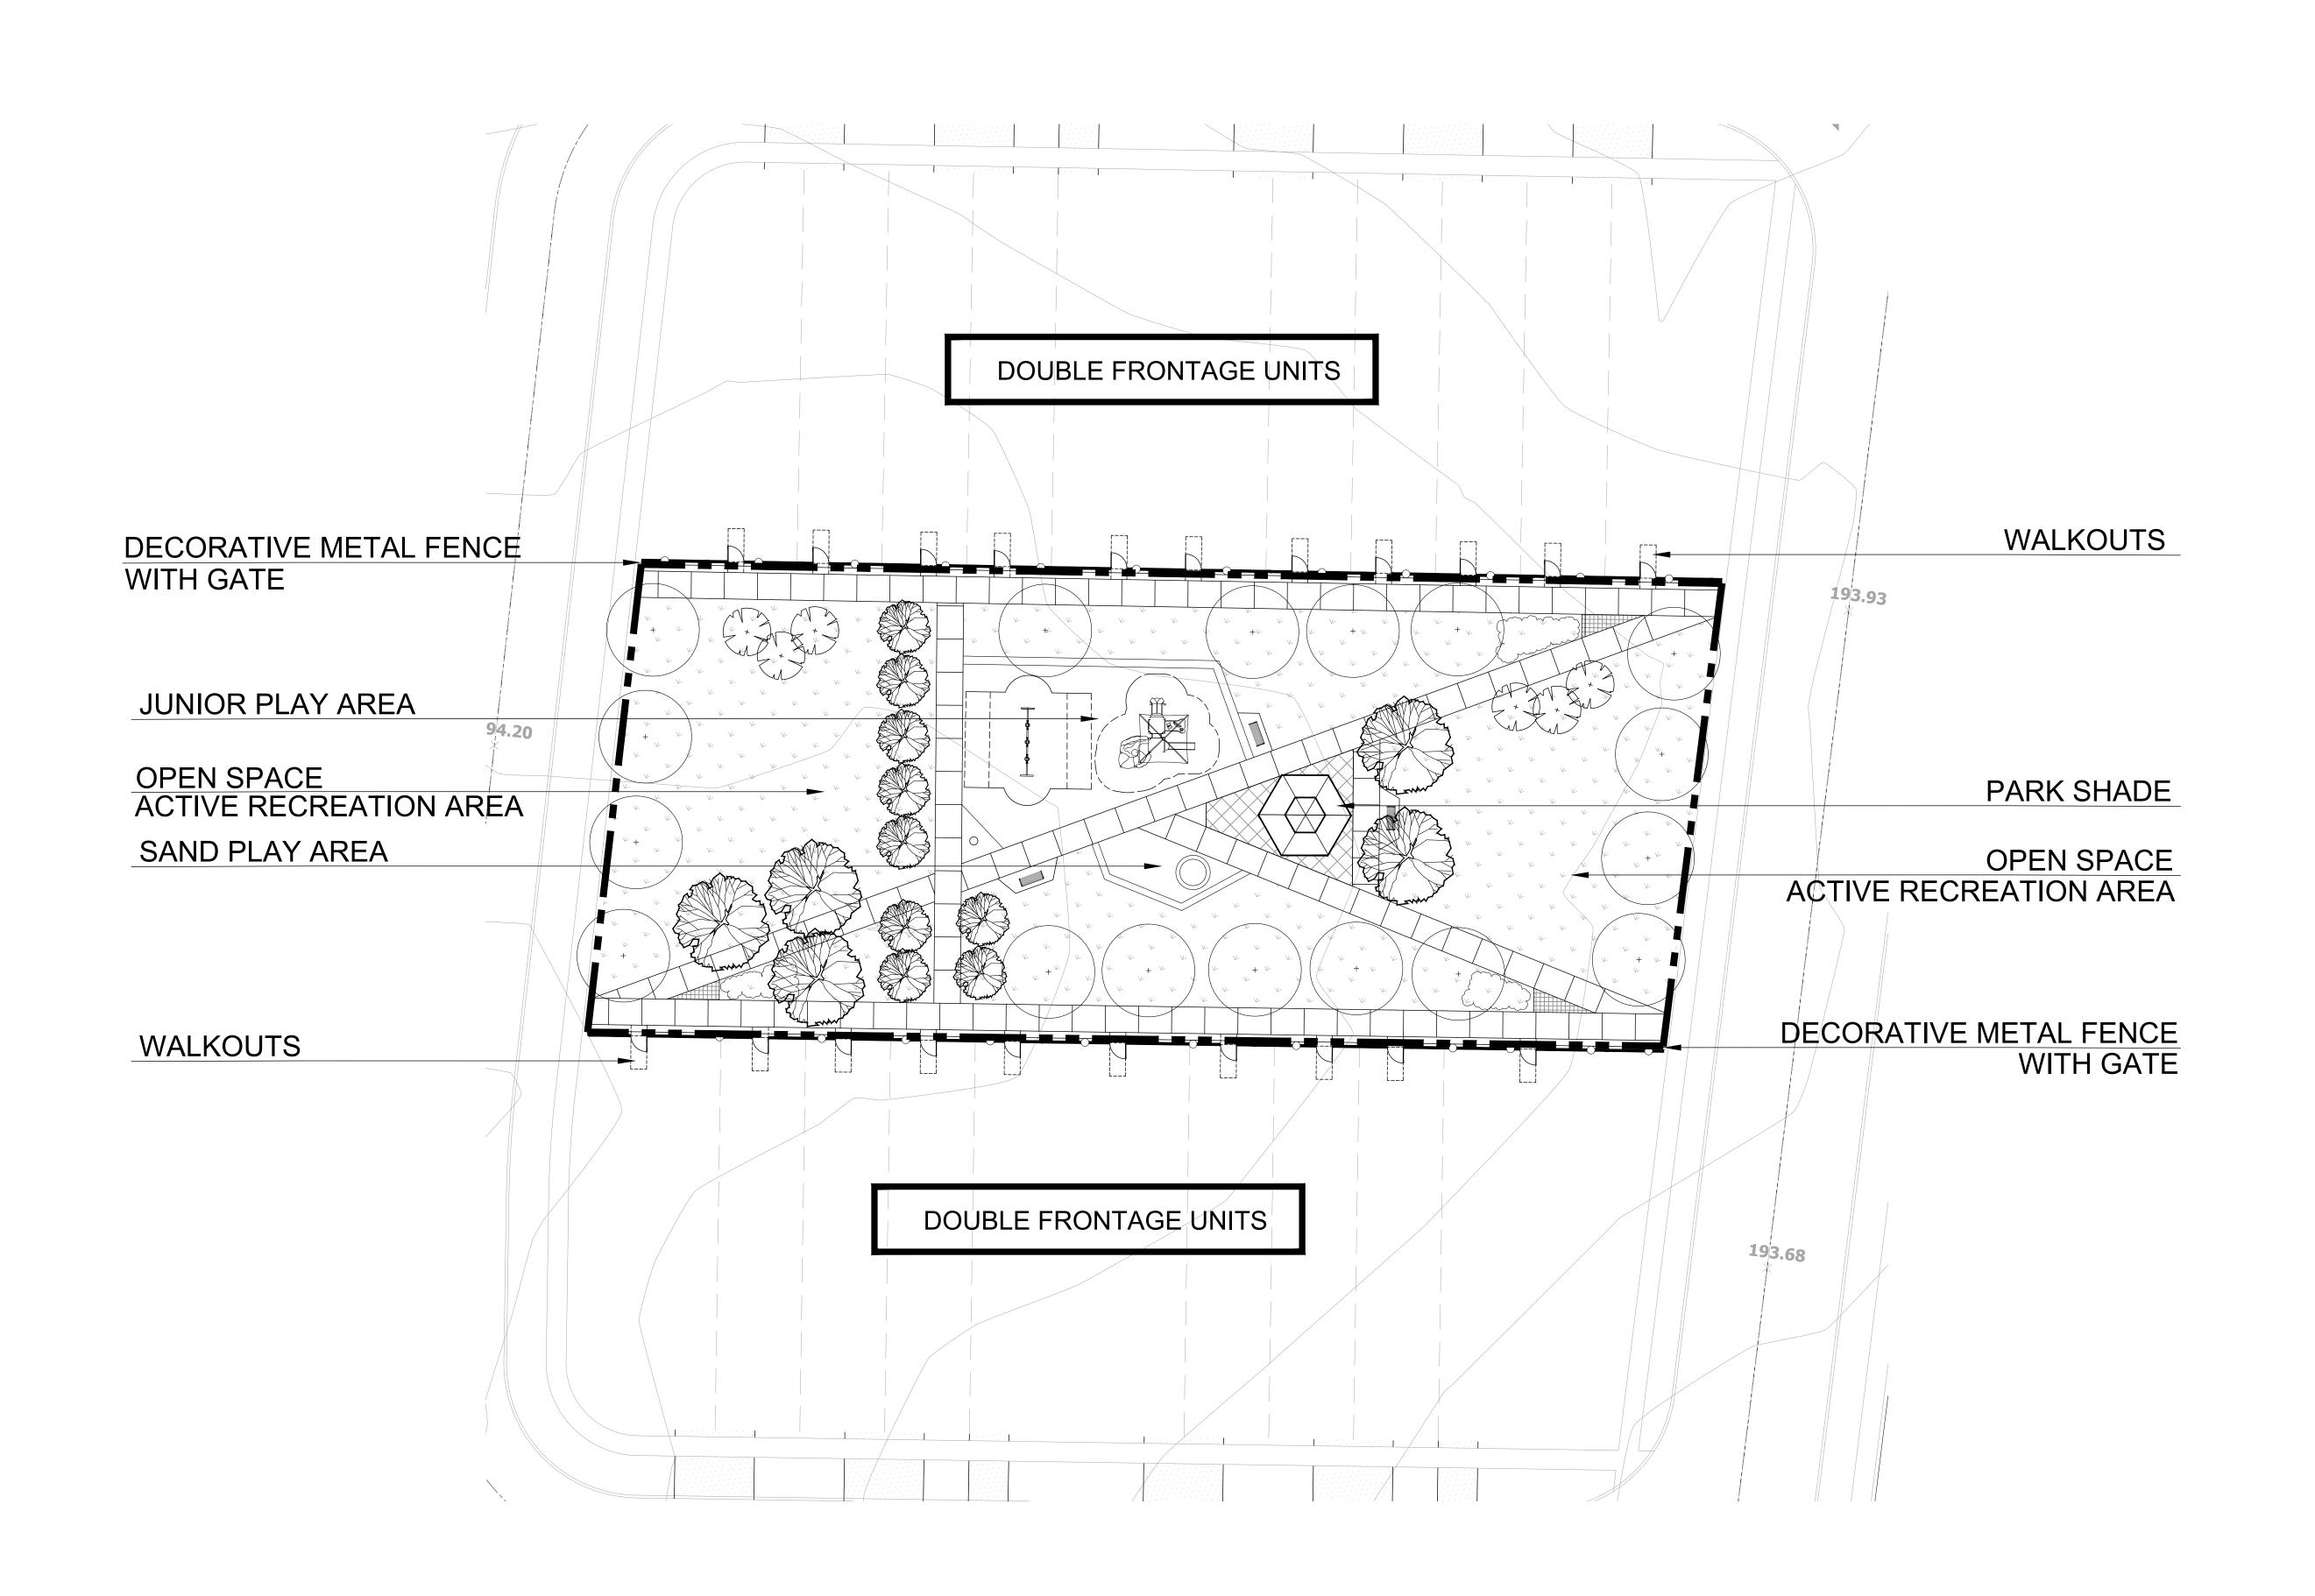

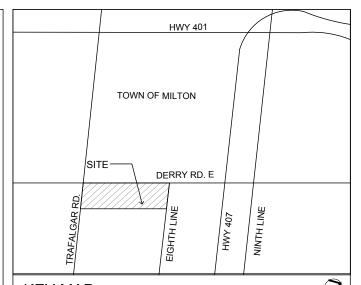

DECORATIVE METAL FENCE WITH GATE

PROPOSED DECIDUOUS TREES





30 CENTURIAN DRIVE, UNIT 105
MARKHAM, ONTARIO, L3R 8B8
Telephone: 905-475-6988 Email info@cgla.ca www.cgla.ca FRONTENAC FOREST ESTATES INC.

TOWN OF MILTON

Project Title: FRONTENAC FOREST

Drawing Title: VILLAGE SQUARE 1 FACILITY FIT

Drawn: CJ 1:250 Date: 20250327


Project Number:

Drawing Number

P3


VILLAGE SQUARE 1



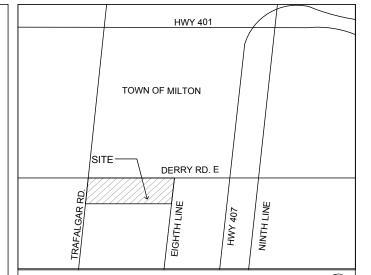

LEGEND:

PROPOSED DECIDUOUS TREES

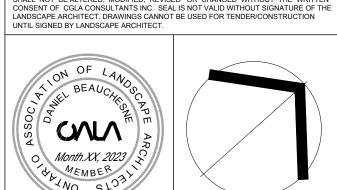



FRONTENAC FOREST ESTATES INC.

TOWN OF MILTON

Project Title: FRONTENAC FOREST

Drawing Title: PARK PRESERVATION LANDSCAPE PLAN

Drawn: CJ 1:250 Date: 20250327

Project Number:

Drawing Number

P4