

TURNER

67 Lesmill Road Toronto, ON, M3B 2T8 T 416 425 2222

turnerfleischer.com

drawing, as an instrument of service, is provided by and is the property of Turner Fleischer

<u>LEGEND</u> PROPOSED ENTRANCE PROPOSED PRIMARY ENTRANCE PROPOSED EXIT PROPOSED FIRE HYDRANT PROPOSED SIGNAGE PROPOSED CONCRETE SIDEWALK PROPOSED CONCRETE PAD

PROPOSED LANDSCAPING DENSE LANDSCAPING

VISIBILITY TRIANGLE


LOADING SPACE


LOUIS ST. LAURENT AVE & BRONTE STREET S

MILTON, ON

#SP-29/22 SITE PLAN

PROJECT NO. 17.042 PROJECT DATE 2024-04-23 DRAWN BY CHECKED BY 1: 750

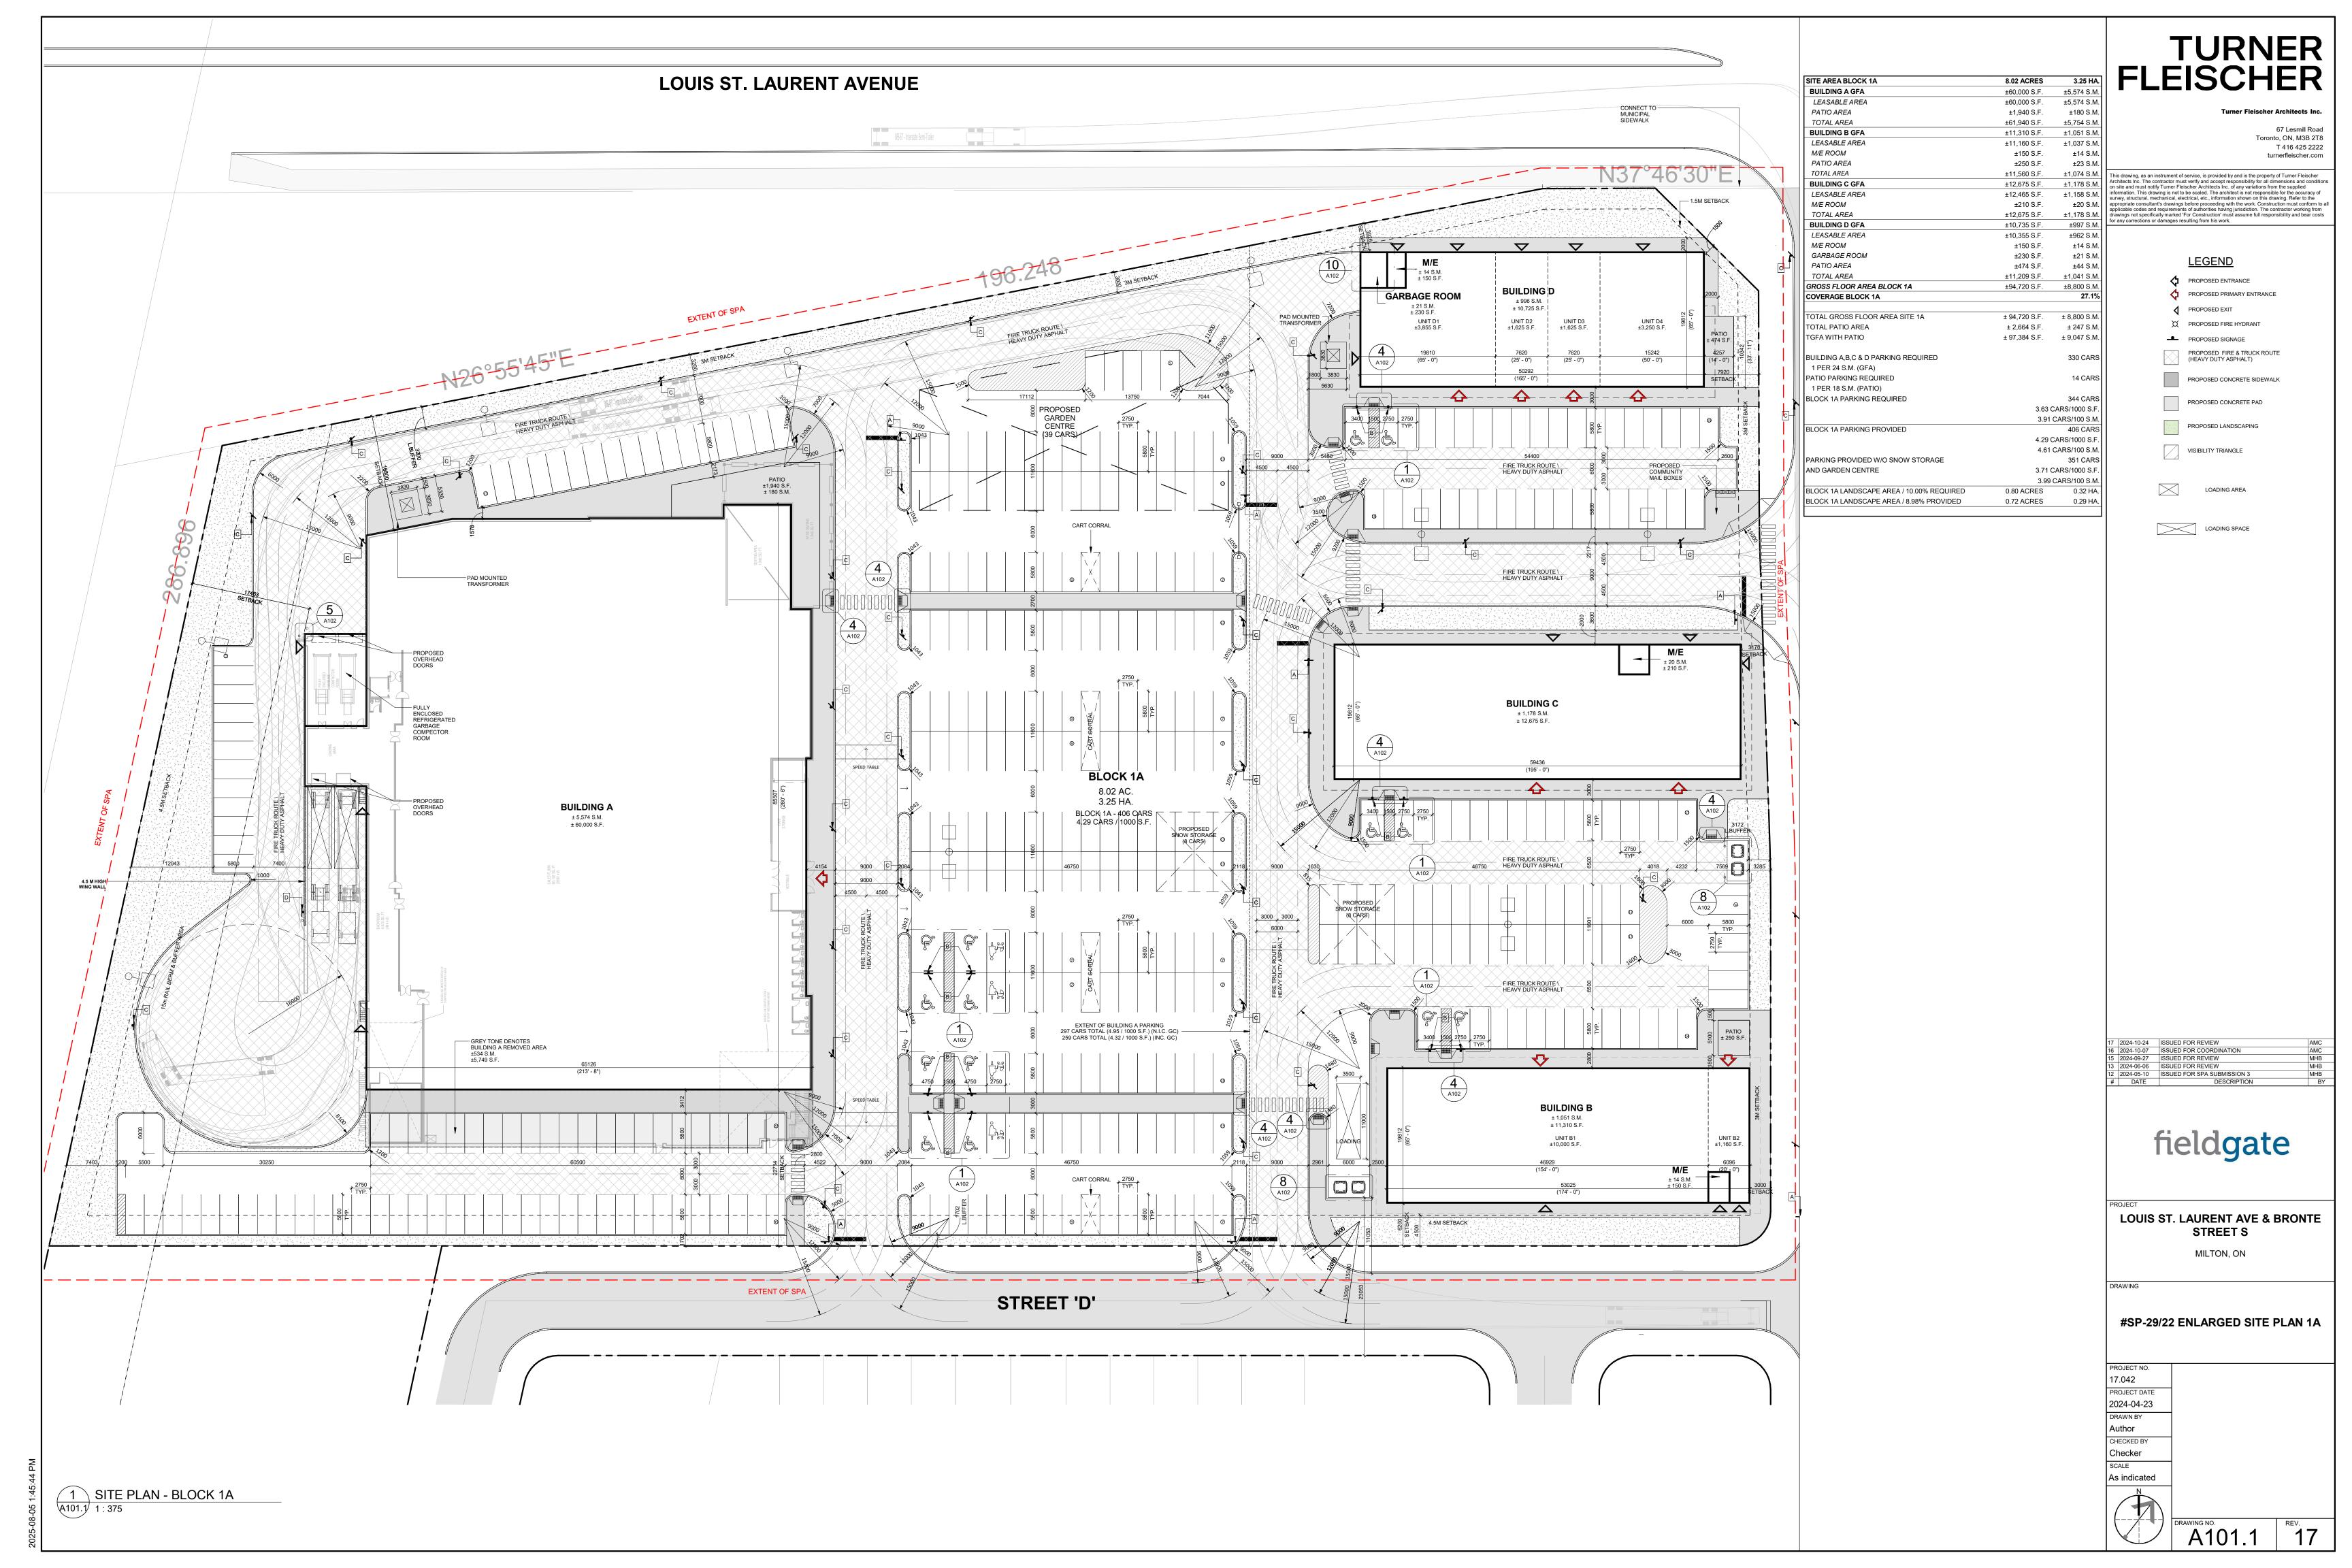

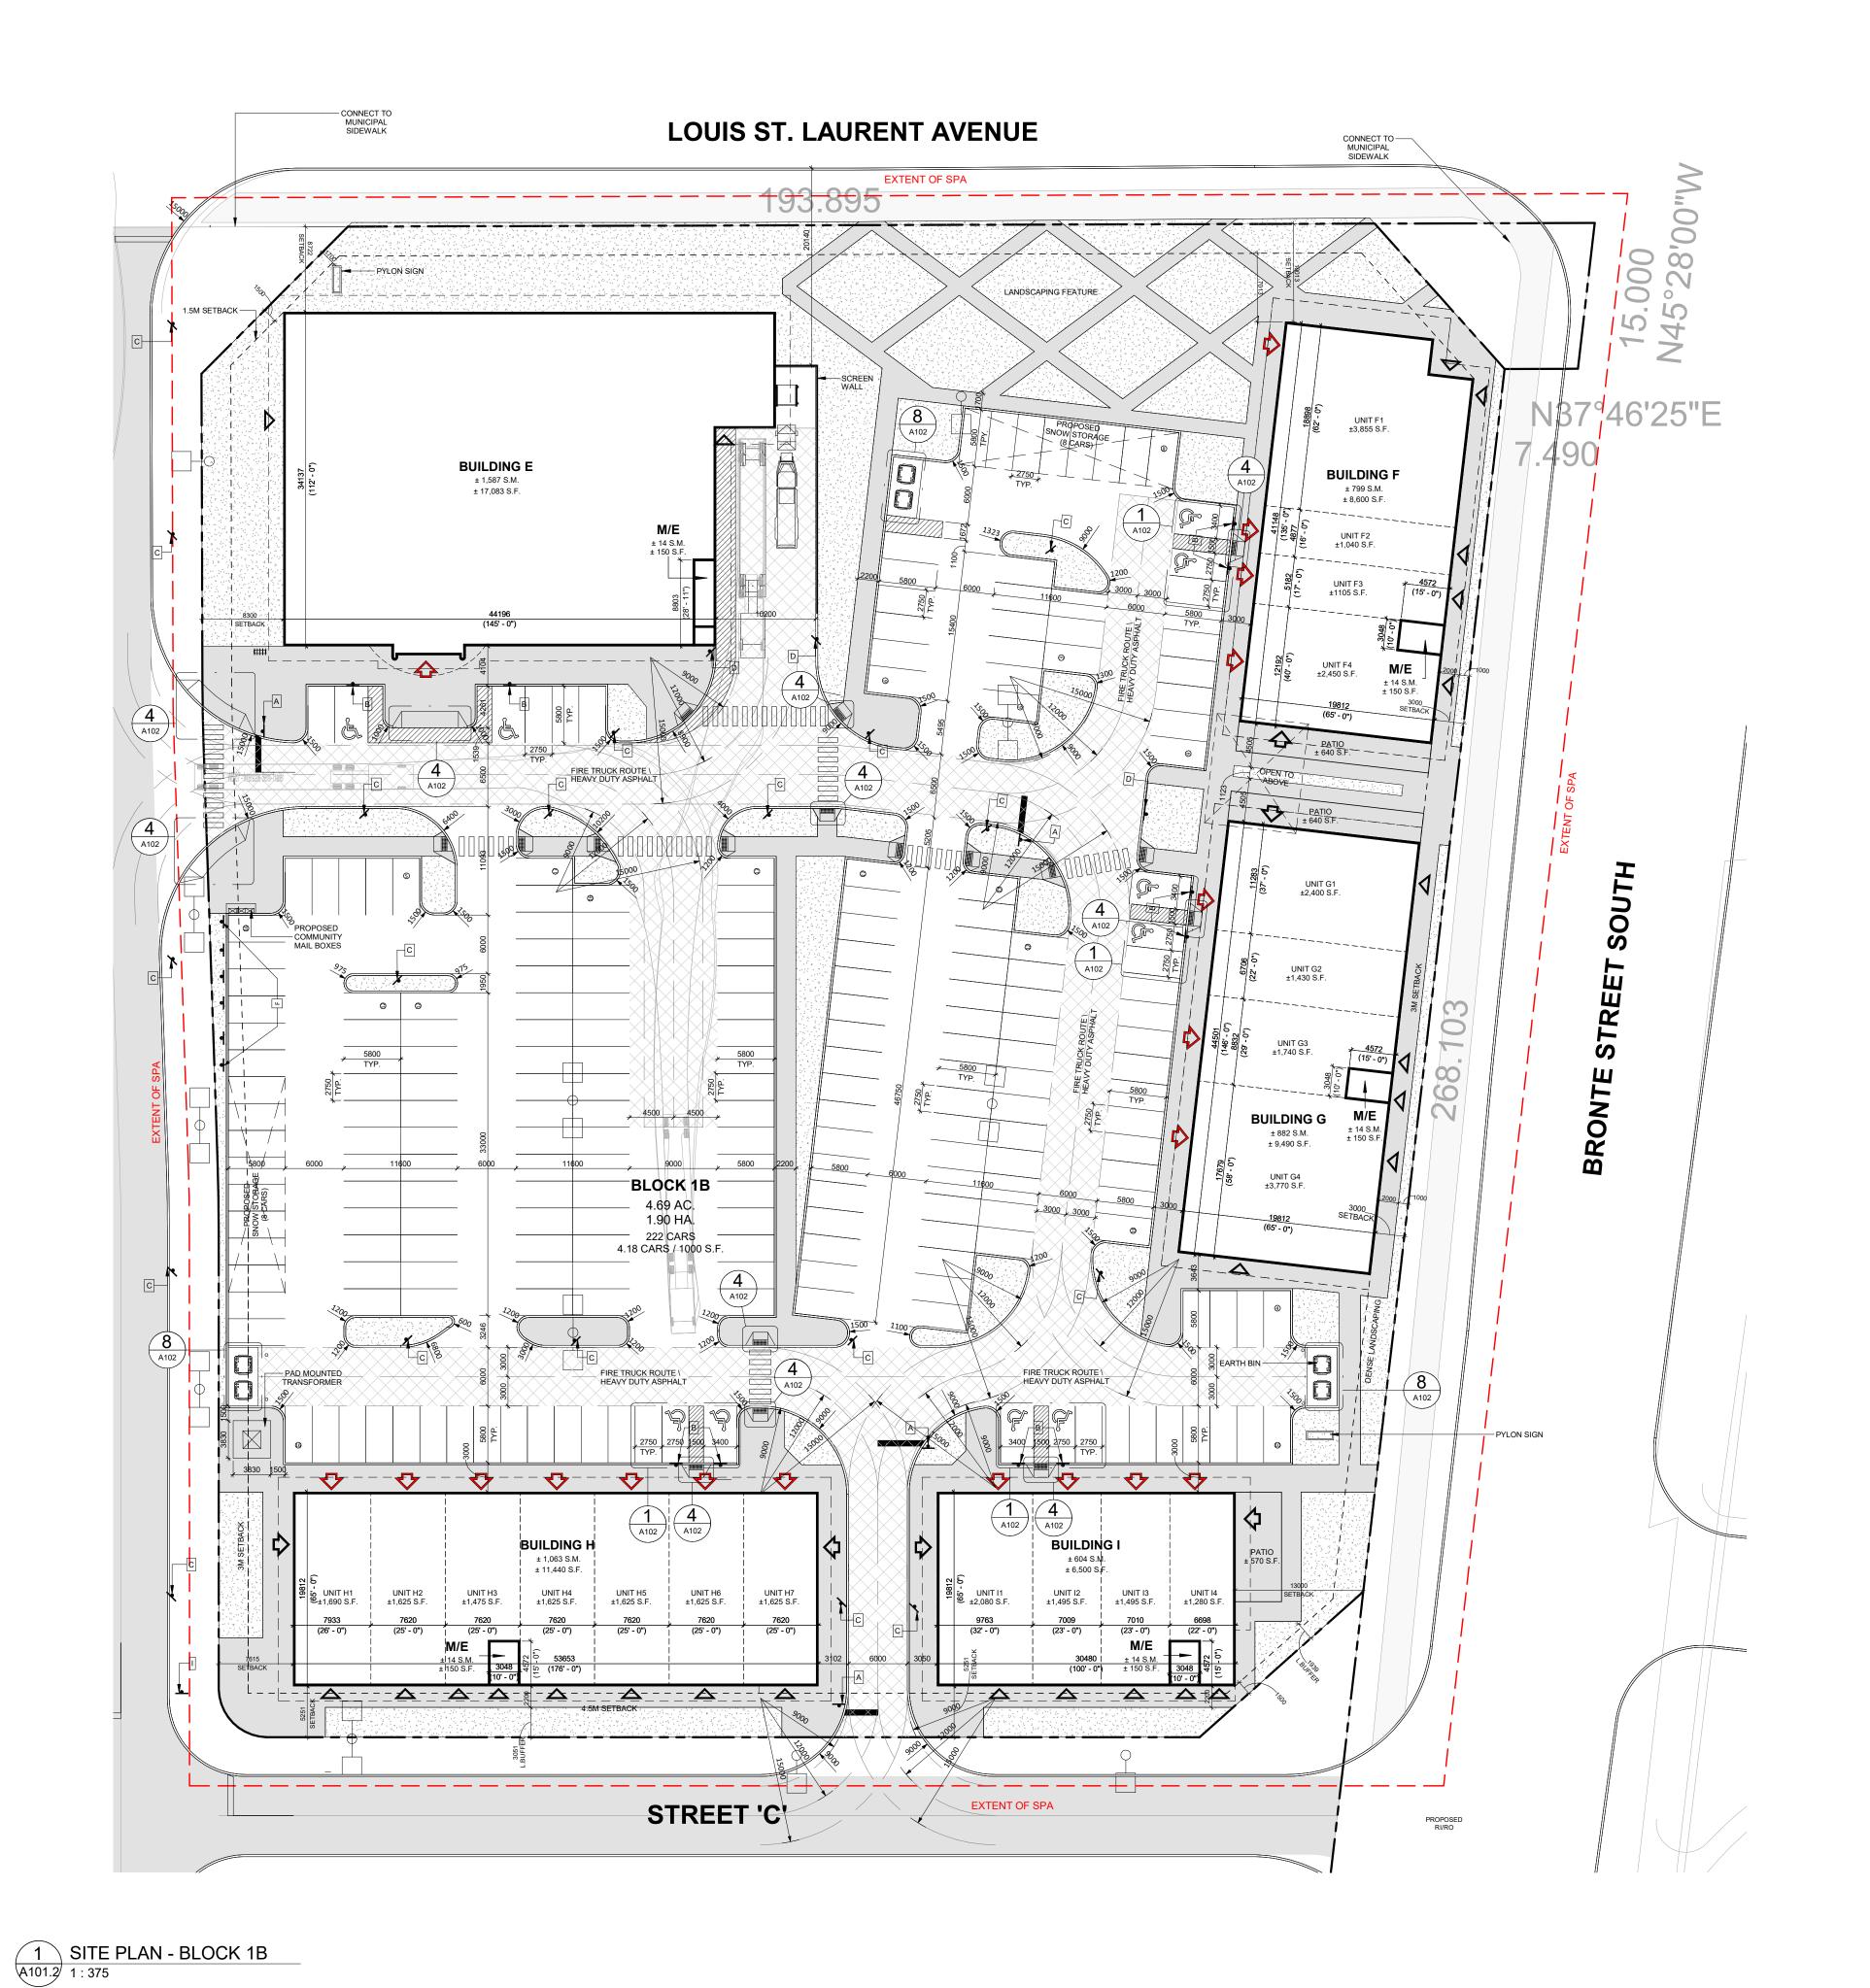

±14 S.M. ±17,083 S.F. ±1,587 S.M. ±8,600 S.F. ±799 S.M. ±8,450 S.F. ±785 S.M. ±150 S.F. ±14 S.M. ±640 S.F. ±59 S.M. ±9,240 S.F. ±858 S.M. ±9,490 S.F. ±882 S.M. ±9,340 S.F. ±868 S.M. ±150 S.F. ±640 S.F. ±59 S.M. ±10,130 S.F. ±941 S.M. ±11,440 S.F. ±1,063 S.M. ±11,290 S.F. ±1,049 S.M. ±150 S.F. ±11,440 S.F. ±1,063 S.M. ±6,500 S.F. ±604 S.M. ±6,350 S.F. ±590 S.M. ±150 S.F. ±14 S.M. ±570 S.F. ±53 S.M. ±7,070 S.F. ±657 S.M. ±53,113 S.F. ±4,934 S.M. ± 53,113 S.F. ± 4,934 S.M. ± 1,850 S.F. ± 172 S.M. ± 54,963 S.F. ± 5,106 S.M. 185 CARS 195 CARS 4.08 CARS/1000 S.F. 4.39 CARS/100 S.M. 222 CARS 4.18 CARS/1000 S.F. 4.50 CARS/100 S.M. 206 CARS 3.88 CARS/1000 S.F. LOADING SPACE 4.17 CARS/100 S.M. 0.47 ACRES 0.19 HA. BLOCK 1B LANDSCAPE AREA / 15.56% PROVIDED 0.73 ACRES 0.29 HA.

SITE AREA BLOCK 1B 4.69 ACRES BUILDING E GFA ±17,083 S.F. LEASABLE AREA ±16,933 S.F. ±1,573 S.M. M/E ROOM + SPRINKLER ROOM ±150 S.F. TOTAL AREA BUILDING F GFA LEASABLE AREA M/E ROOM PATIO AREA TOTAL AREA **BUILDING G GFA** LEASABLE AREA M/E ROOM PATIO AREA TOTAL AREA BUILDING H GFA LEASABLE AREA M/E ROOM TOTAL AREA **BUILDING I GFA** LEASABLE AREA M/E ROOM PATIO AREA TOTAL AREA GROSS FLOOR AREA BLOCK 1B COVERAGE BLOCK 1B TOTAL GROSS FLOOR AREA SITE 1B TOTAL PATIO AREA TGFA WITH PATIO BUILDING E,F,G, H & I PARKING REQUIRED 1 PER 24 S.M. (GFA) PATIO PARKING REQUIRED 1 PER 18 S.M. (PATIO) BLOCK 1B PARKING W/ PATIO REQUIRED BLOCK 1B PARKING PROVIDED PARKING PROVIDED W/O SNOW STORAGE BLOCK 1B LANDSCAPE AREA / 10.00% REQUIRED

TURNER FLEISCHER

67 Lesmill Road Toronto, ON, M3B 2T8 T 416 425 2222 turnerfleischer.com

This drawing, as an instrument of service, is provided by and is the property of Turner Fleischer Architects Inc. The contractor must verify and accept responsibility for all dimensions and condition on site and must notify Turner Fleischer Architects Inc. of any variations from the supplied on site and must notity lurner Fleischer Architects Inc. of any variations from the supplied information. This drawing is not to be scaled. The architect is not responsible for the accuracy of survey, structural, mechanical, electrical, etc., information shown on this drawing. Refer to the appropriate consultant's drawings before proceeding with the work. Construction must conform to applicable codes and requirements of authorities having jurisdiction. The confractor working from drawings not specifically marked 'For Construction' must assume full responsibility and bear costs for any corrections or damages resulting from his work.

<u>LEGEND</u> PROPOSED ENTRANCE PROPOSED PRIMARY ENTRANCE C PROPOSED FIRE HYDRANT PROPOSED SIGNAGE PROPOSED FIRE & TRUCK ROUTE (HEAVY DUTY ASPHALT) PROPOSED CONCRETE SIDEWALK PROPOSED CONCRETE PAD PROPOSED LANDSCAPING VISIBILITY TRIANGLE LOADING AREA

| 16 | 2024-10-07 | ISSUED FOR COORDINATION | 12 | 2024-05-10 | ISSUED FOR SPA SUBMISSION 3 | 11 | 2024-04-25 | ISSUED FOR SPA | 10 | 2024-03-27 | ISSUED FOR COORDINATION | 9 | 2024-03-04 | ISSUED FOR COORDINATION | # | DATE | DESCRIPTION |

fieldgate


LOUIS ST. LAURENT AVE & BRONTE STREET S


MILTON, ON

#SP-29/22 ENLARGED SITE PLAN 1B

PROJECT NO. 17.042 PROJECT DATE 2024-04-23 Author CHECKED BY Checker As indicated

16 A101.2

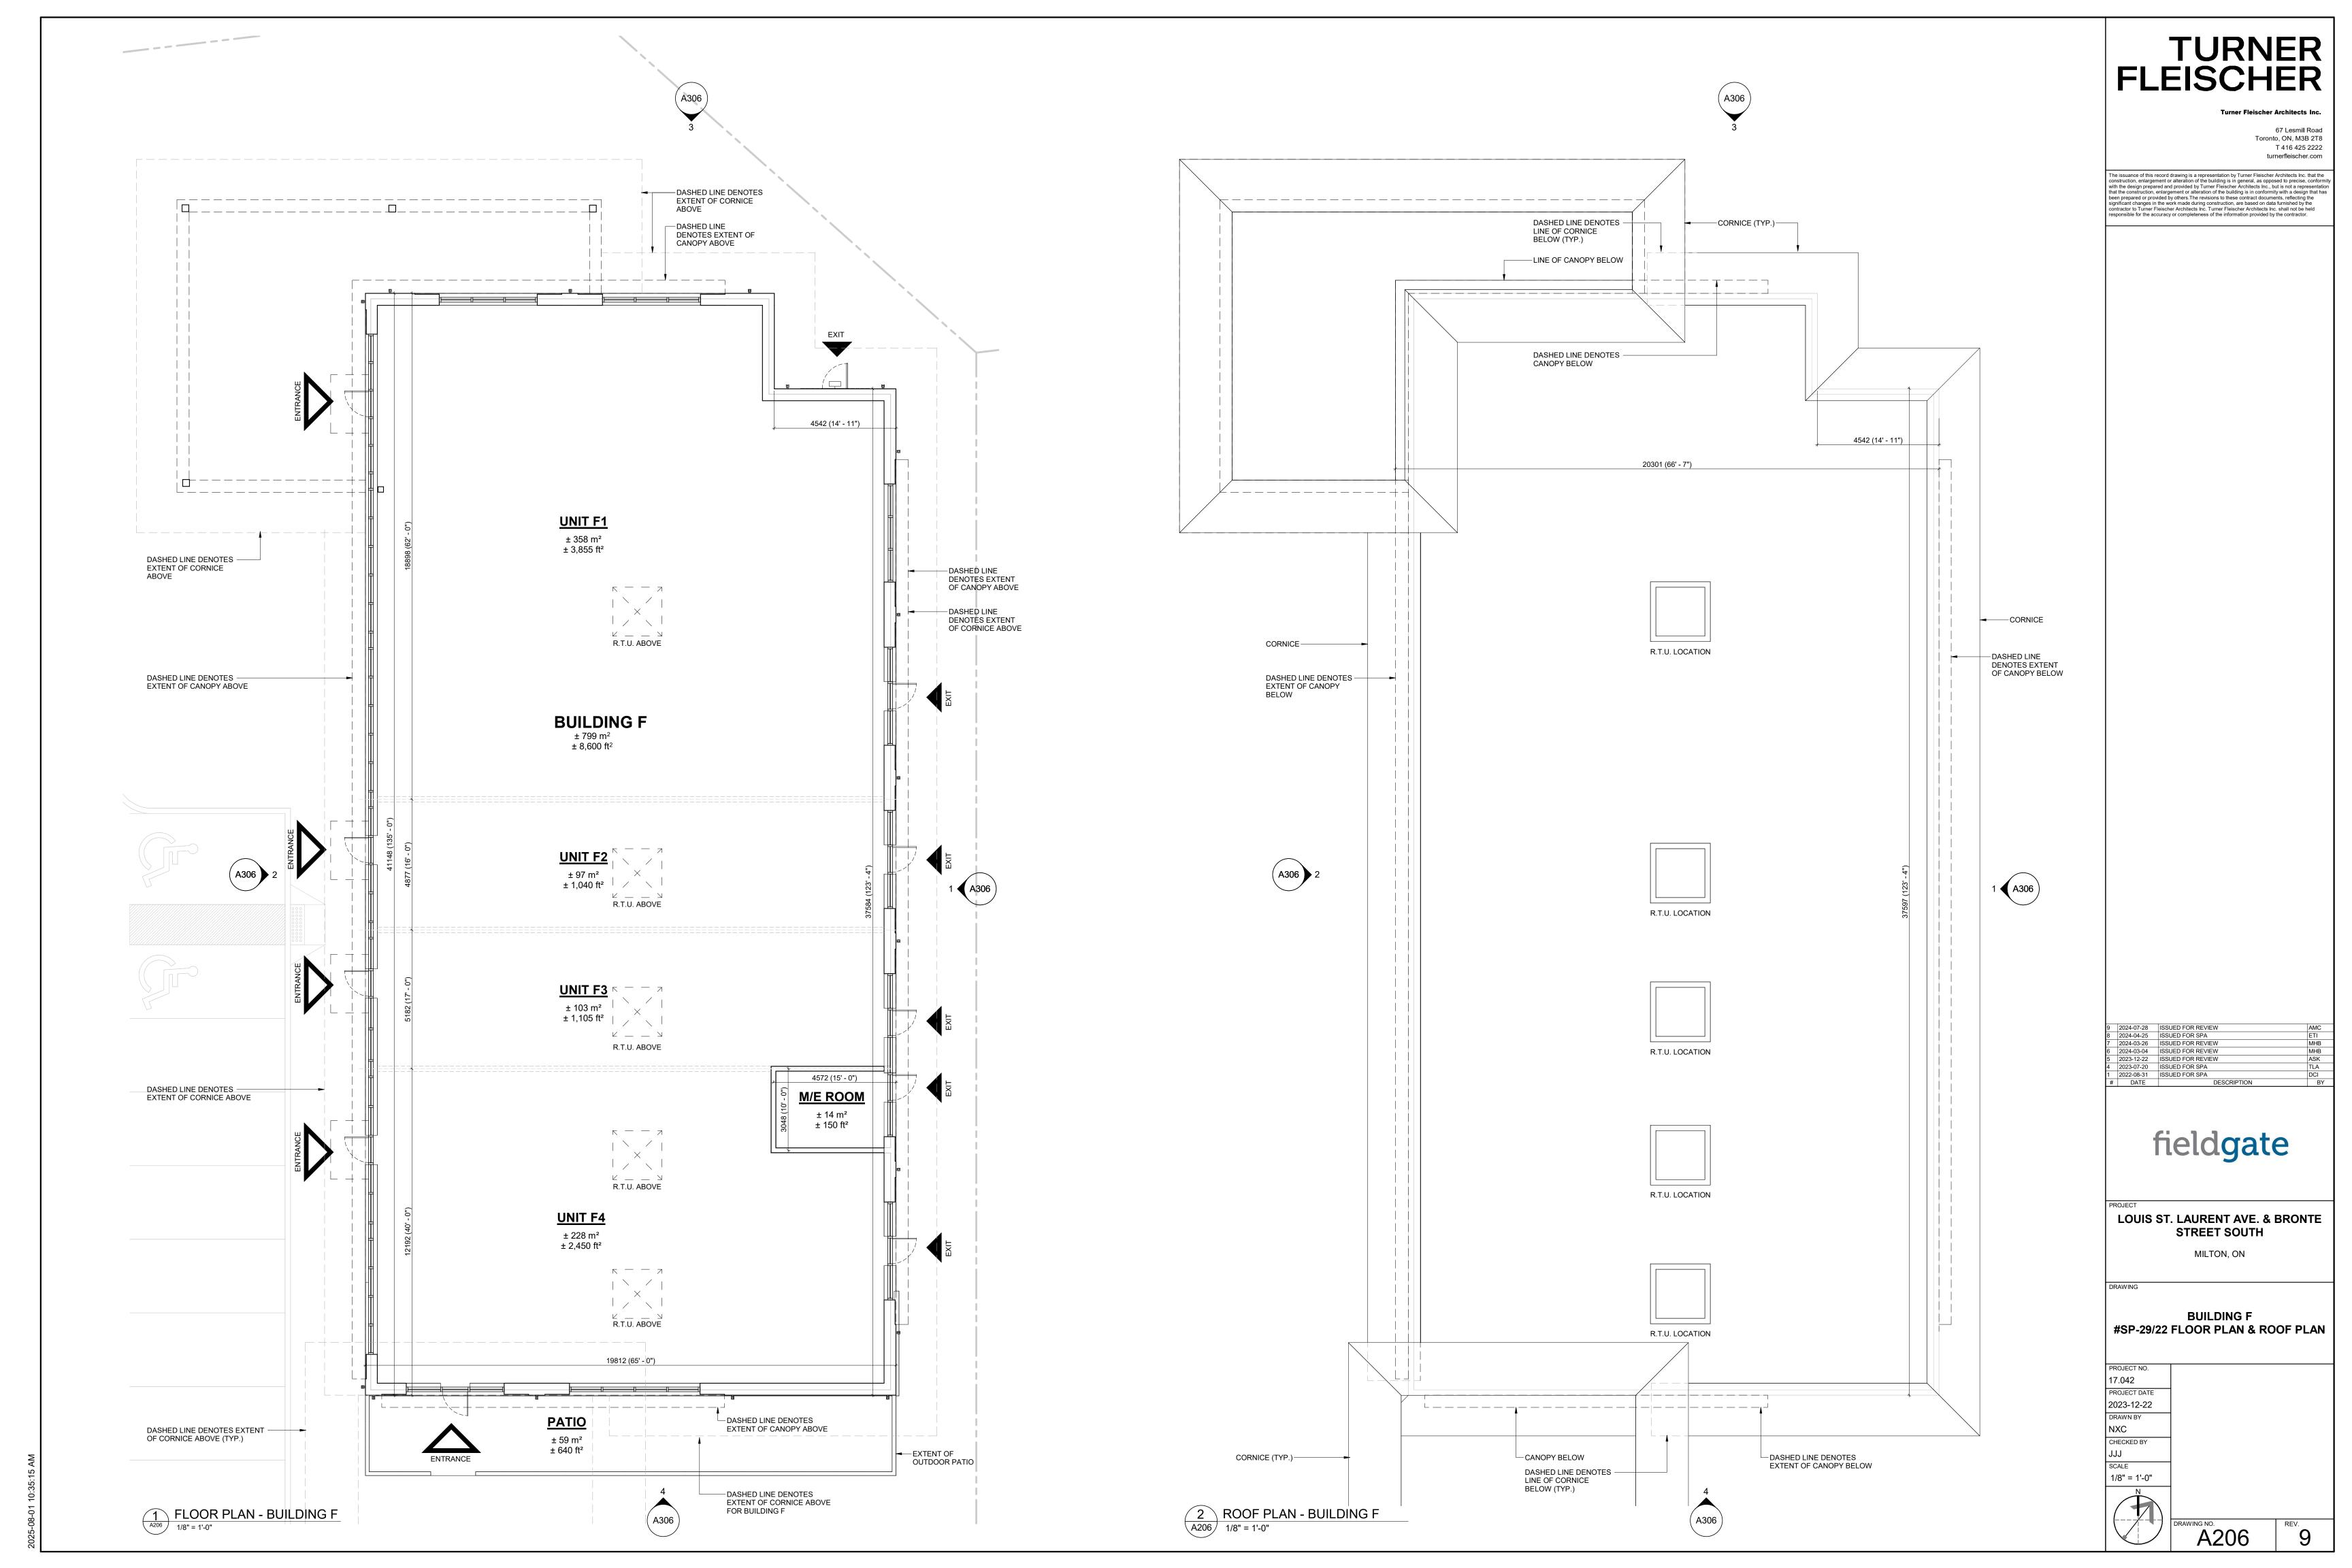

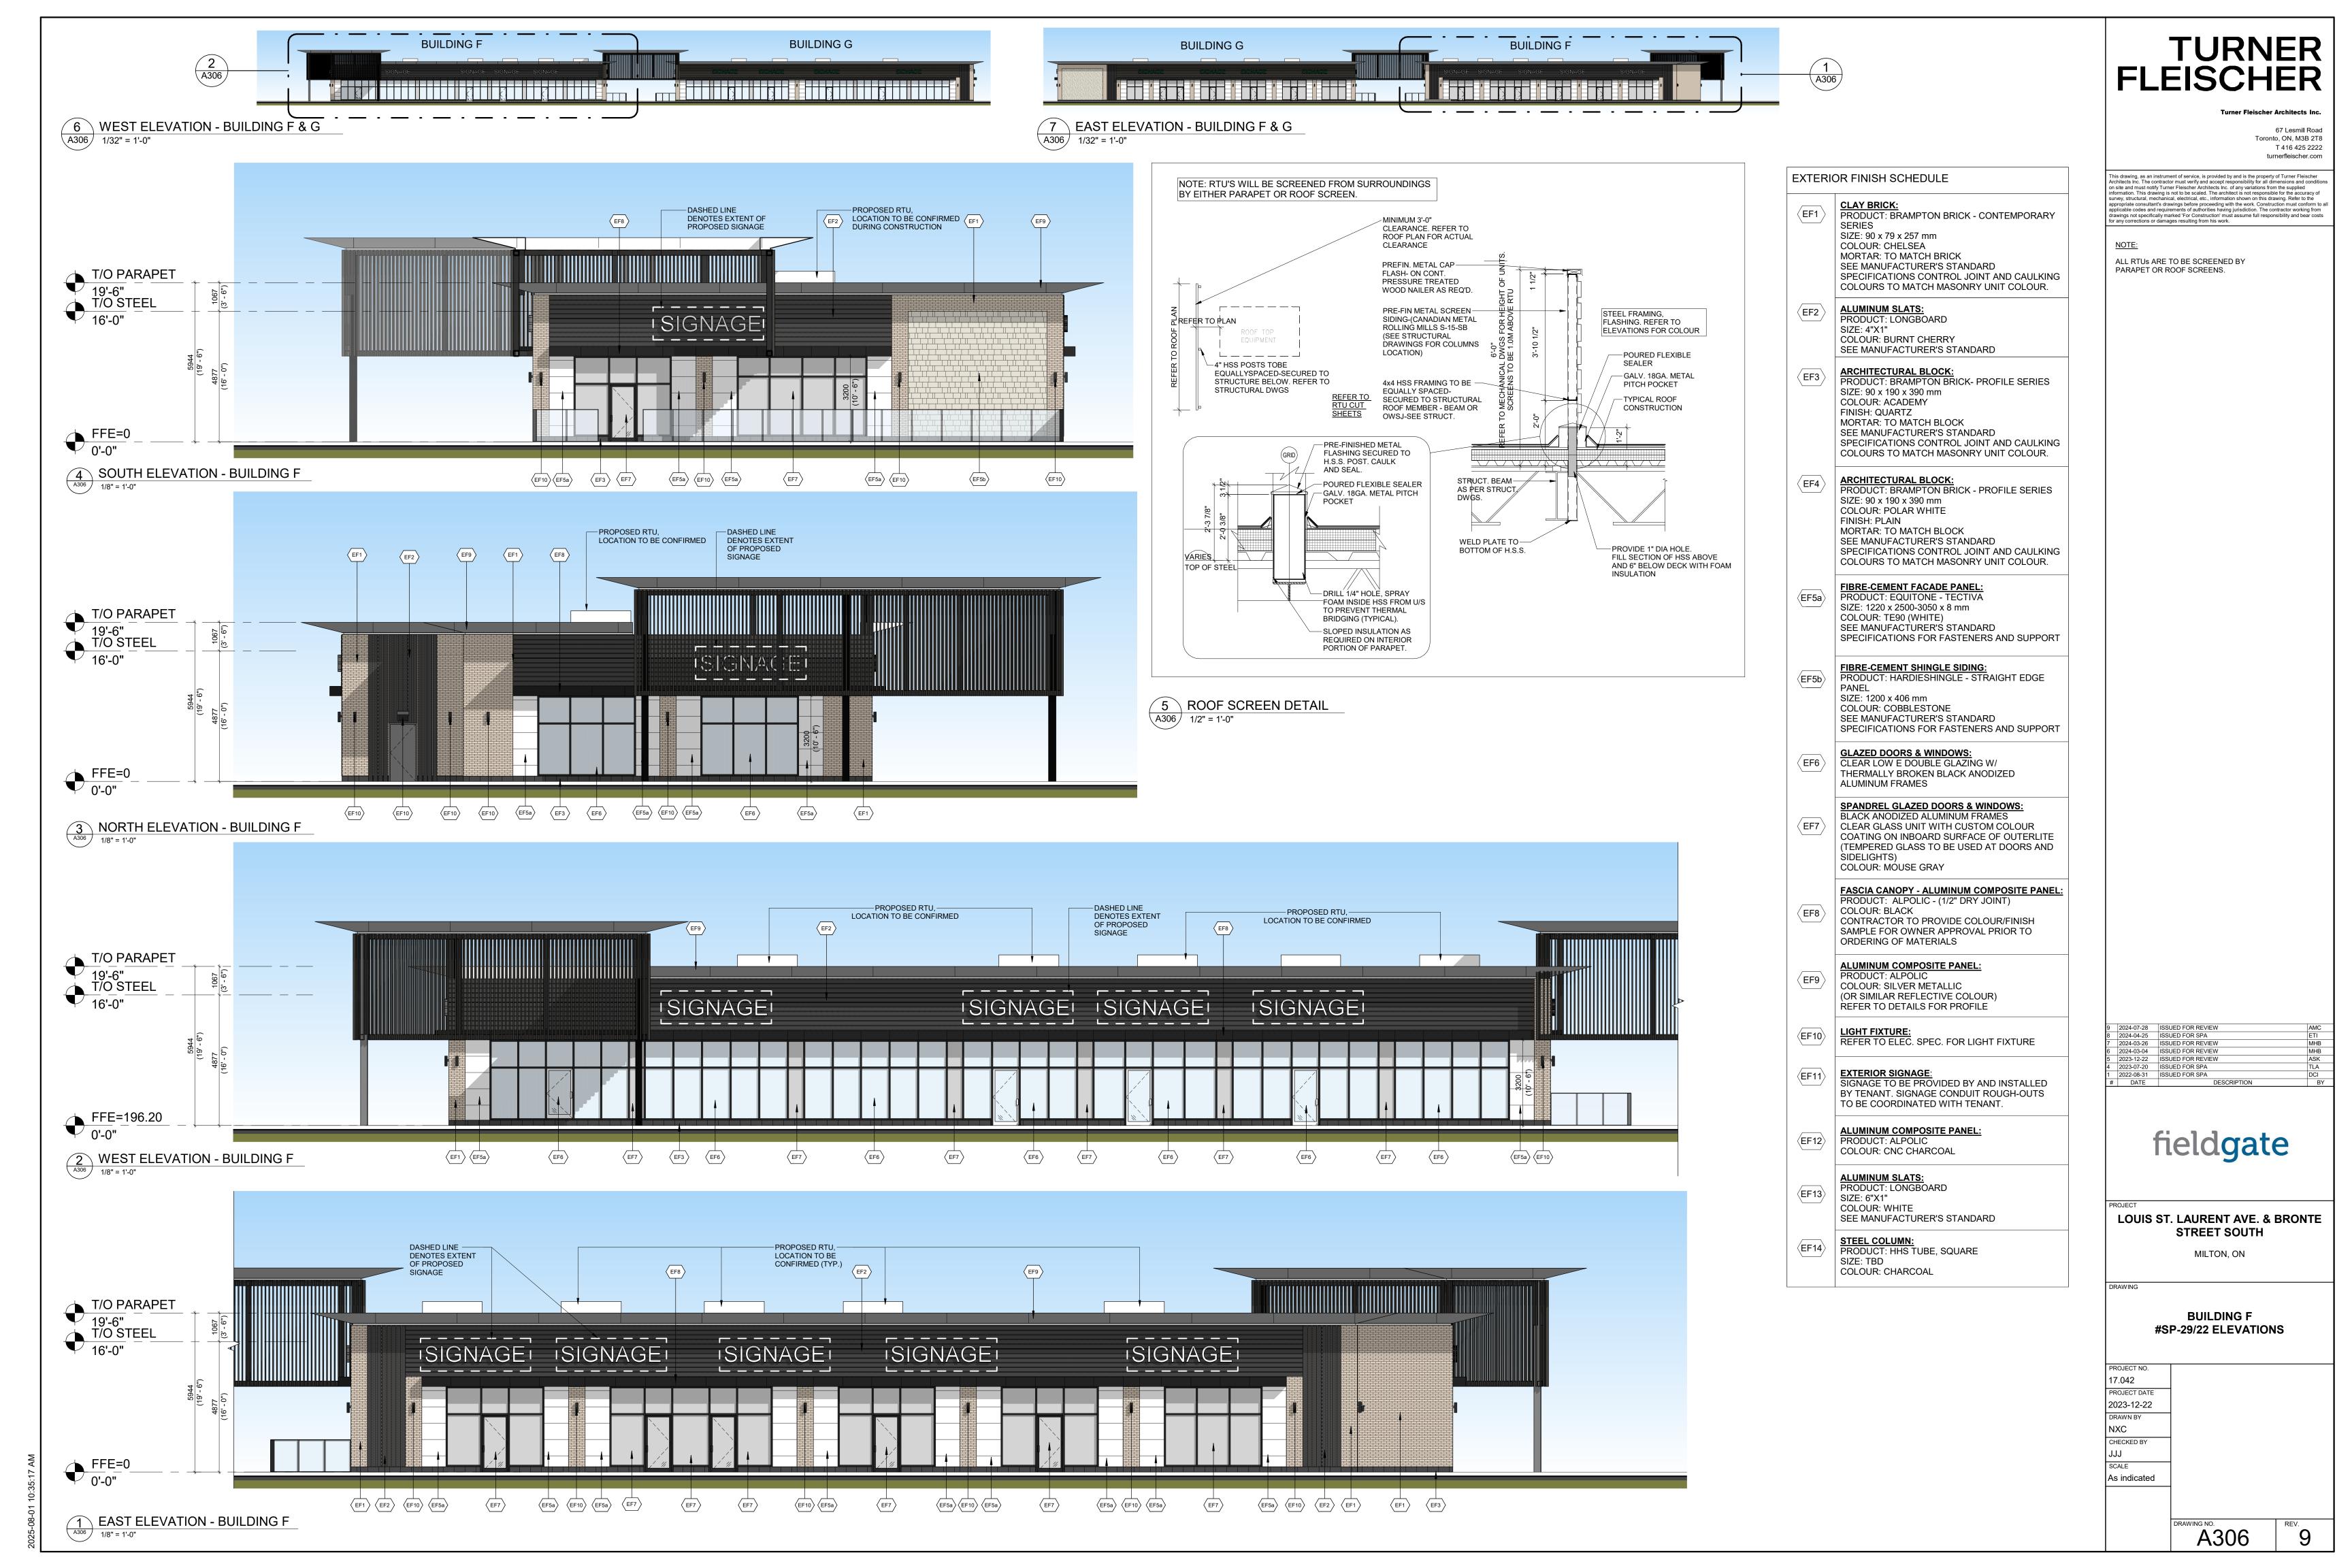

3.00		Onta	rio B	suild		de Data N	natrix				Building Code Reference	
					Part 3						Reterence	
3.01	Building Code Version: Project Type:	⊠ New □ Change	O. Reg. 332/12 Last Amendment 451/22. New □ Additional □ Renovation □ Change of use □ Addition and renovation Description:							[A] 1.1.2.		
3.02	Major Occupancy Classification:	Occupancy Group E Mercantile				Use Retail				3.1.2.1(1)		
3.03	Superimposed Major	⊠ No □ Yes Description:								3.2.2.7		
3.04	Occupancies: Building Area (m²)	Descriptio	n:				E	isting	New	Total	[A] 1.4.1.2.	
3.05 3.07	Gross Area (m²) Building Height	Description 1	s	-	above g		E) 5.94	<u>0</u> sisting (m) Abo	779 New ve grade	779 Total	[A] 1.4.1.2. [A] 1.4.1.2. &	
3.08	High Building Number of Streets/	⊠ No								3.2.1.1. 3.2.6 3.2.2.10. &		
3.10	Firefighter access Building Classification: (Size	Major Classification:								3.2.5.		
	and Construction Relative to Occupancy)	Group E, up to 2 Storeys, Sprinklered									2 2 2 62	
3.11	Sprinkler System	Group E, u ⊠ Require		<u>oiore)</u>	<u>/s, Sprink</u> □ Not R						3.2.2.62.	
	эрпікіеї зуѕіепі	Proposed	Proposed: ⊠ Entire building □ Selected compartments □ Selected floor areas □ Basement □ In lieu of roof rating □ None							3.2.1.5. & 3.2.2.17.		
3.12	Standpipe System Fire Alarm System		□ Required									
3.14	Water Service/	Proposed: ☐ Single Stage ☐ Two Stage ☐ None										
3.14	Supply is Adequate Construction Type:	□ No ☑ Yes Restriction: ☑ Combustible permitted □ Non-combustible required Actual: □ Combustible □ Non-combustible □ Combination Heavy Timber Construction: ☑ No □ Yes									3.2.20-83 &	
3.18	Occupant Load	Floor Lev Area			ссирапсу Туре Туре		Use	Based On	m² per person Load	Occupant Load (Persons)	3.1.17.	
		799			Basements Store	ys	m² per person Design of space	3.7 N/A	<u>215</u>			
3.19	Barrier-Free Design: Hazardous	□ Yes ☑ No □ Yes	Explan	ation:						3.3.1.2 &		
	Substances:	⊠ No									3.3.1.19.	
3.21	Required Fire Resistance Rating:	Horizontal Assembly Rating (H) Supporting Assembly(H) Noncombustible in lieu of rating? Floors over Assembly N/A N/A N/A								3.2.2.62. 3.2.1.4		
		basement			<u>N/A</u> <u>0.75</u>	<u>N/A</u> <u>0.75</u>			<u>N/A</u>			
		Mezzanine		<u>0.75</u> <u>N/A</u> <u>N/A</u>		<u>0.75</u> <u>N/A</u>			<u>N/A</u>			
		Roof										
		FACE	Area of EBF	L.D.	L/H or	Permitted Max.% of	Propose d	FRR (Hours)	LISTED DESIGN OF	Exterior Wall Construction	Exterior Wall	
3.22	Spatial Separation -		(m²)	(,	H/L	Openings (%)	% of Opening s (%)		DESCRIPTION N		Cladding Type	
3.22	Spatial Separation - Construction of Exterior Walls							-	N/A	-	-	
3.22	Construction of	North South	108.7	23.9	3:1 to 10:1	100.00	15.7 25.7	-	N/A	-	-	
3.22	Construction of				10:1 3:1 to 10:1					- Combustible or	- Combustible or	
3.22	Construction of	South	83.7	29.9	3:1 to 10:1 3:1 to 10:1	100.00	25.7	-	N/A	-	-	



67 Lesmill Road Toronto, ON, M3B 2T8 T 416 425 2222 turnerfleischer.com

This drawing, as an instrument of service, is provided by and is the property of Turner Fleischer Architects Inc. The contractor must verify and accept responsibility for all dimensions and conditions on site and must notify Turner Fleischer Architects Inc. of any variations from the supplied information. This drawing is not to be scaled. The architect is not responsible for the accuracy of survey, structural, mechanical, electrical, etc., information shown on this drawing. Refer to the appropriate consultant's drawings before proceeding with the work. Construction must conform to all applicable codes and requirements of authorities having jurisdiction. The contractor working from drawings not specifically marked 'For Construction' must assume full responsibility and bear costs for any corrections or damages resulting from his work.

8 2024-04-25 ISSUED FOR SPA
7 2024-03-26 ISSUED FOR REVIEW
6 2024-03-04 ISSUED FOR REVIEW
4 2023-07-20 ISSUED FOR SPA
1 2022-08-31 ISSUED FOR SPA
DATE DESCRIPTION

fieldgate


LOUIS ST. LAURENT AVE. & BRONTE STREET SOUTH

MILTON, ON

BUILDING F #SP-29/22 OBC MATRIX

PROJECT NO.
17.042
PROJECT DATE
2023-12-22
DRAWN BY
TLA
CHECKED BY
JJJ
SCALE

REV. A406

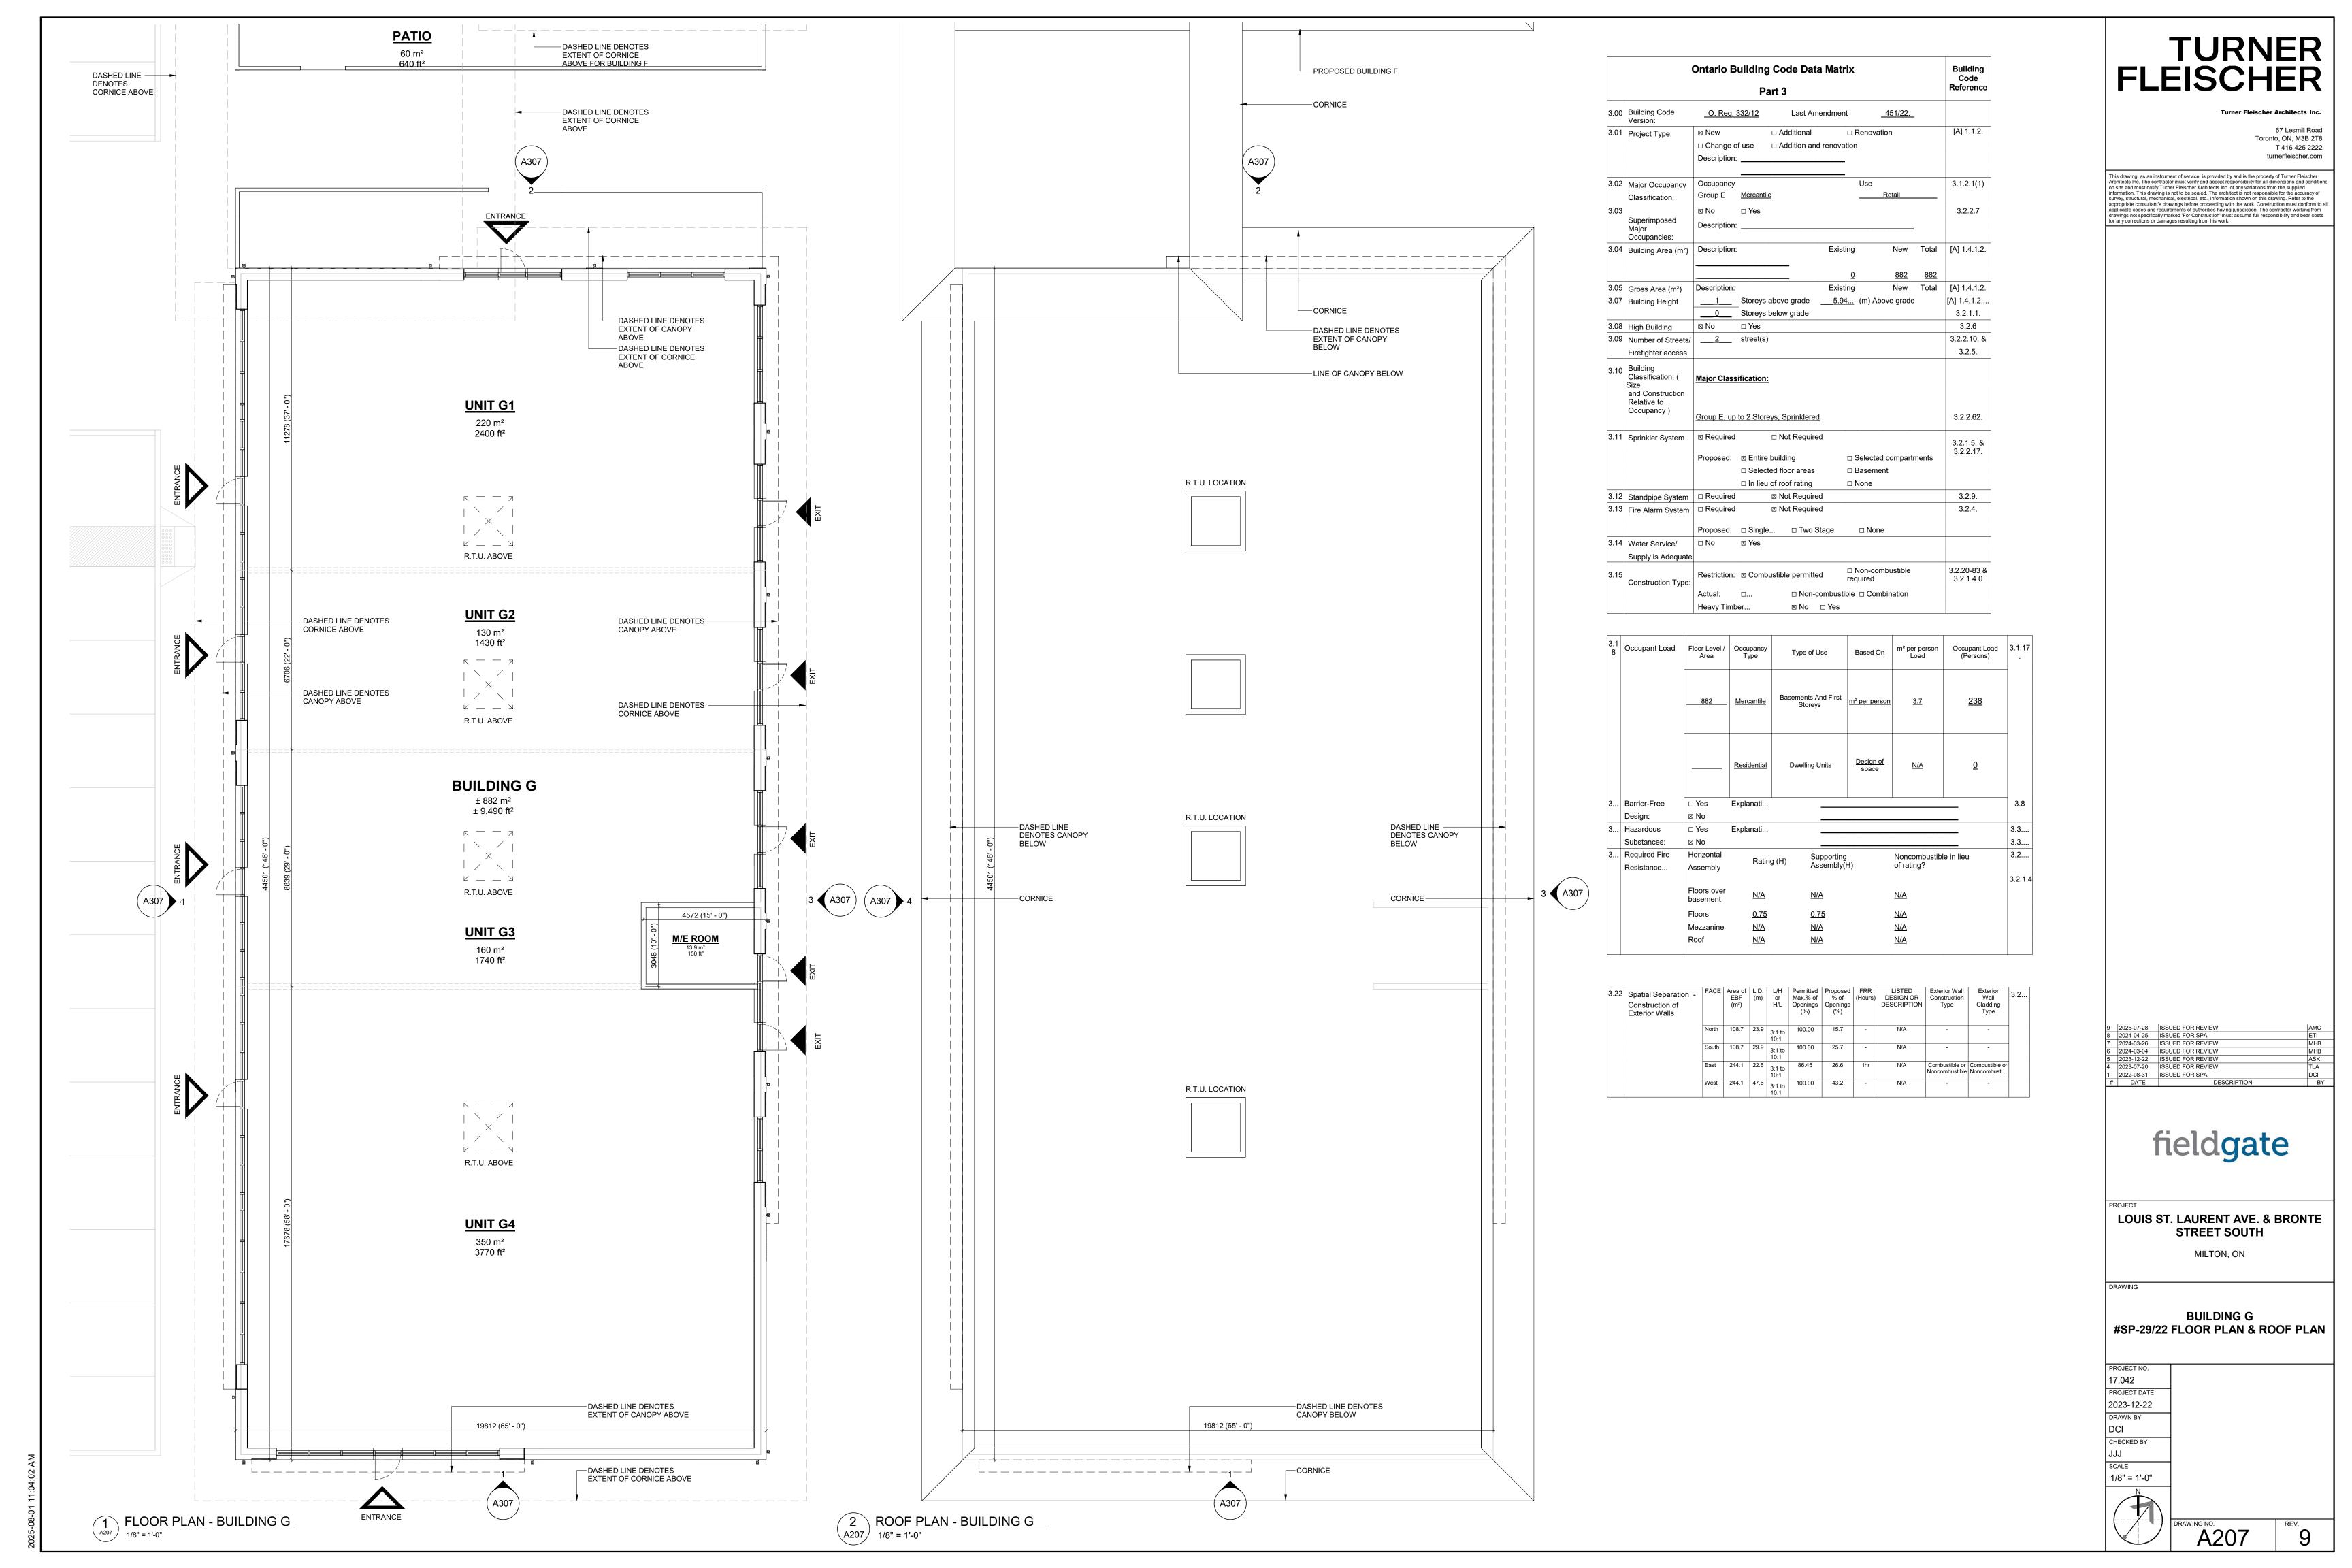



TURNER EXTERIOR FINISH SCHEDULE FLEISCHER

CLAY BRICK:
PRODUCT: BRAMPTON BRICK - CONTEMPORARY

SPECIFICATIONS CONTROL JOINT AND CAULKING

COLOURS TO MATCH MASONRY UNIT COLOUR.

ARCHITECTURAL BLOCK:
PRODUCT: BRAMPTON BRICK- PROFILE SERIES
SIZE: 90 x 190 x 390 mm

SPECIFICATIONS CONTROL JOINT AND CAULKING

ARCHITECTURAL BLOCK:
PRODUCT: BRAMPTON BRICK - PROFILE SERIES

SPECIFICATIONS CONTROL JOINT AND CAULKING

SPECIFICATIONS FOR FASTENERS AND SUPPORT

FIBRE-CEMENT SHINGLE SIDING:
PRODUCT: HARDIESHINGLE - STRAIGHT EDGE

SPECIFICATIONS FOR FASTENERS AND SUPPORT

COLOURS TO MATCH MASONRY UNIT COLOUR.

COLOURS TO MATCH MASONRY UNIT COLOUR.

SERIES

SIZE: 4"X1"

 $\langle \mathsf{EF2} \rangle$

SIZE: 90 x 79 x 257 mm

MORTAR: TO MATCH BRICK

ALUMINUM SLATS: PRODUCT: LONGBOARD

COLOUR: BURNT CHERRY

COLOUR: ACADEMY FINISH: QUARTZ

SIZE: 90 x 190 x 390 mm COLOUR: POLAR WHITE

MORTAR: TO MATCH BLOCK

SEE MANUFACTURER'S STANDARD

FIBRE-CEMENT FACADE PANEL: PRODUCT: EQUITONE - TECTIVA

SEE MANUFACTURER'S STANDARD

SEE MANUFACTURER'S STANDARD

GLAZED DOORS & WINDOWS: CLEAR LOW E DOUBLE GLAZING W/

THERMALLY BROKEN BLACK ANODIZED

SPANDREL GLAZED DOORS & WINDOWS: BLACK ANODIZED ALUMINUM FRAMES

CLEAR GLASS UNIT WITH CUSTOM COLOUR COATING ON INBOARD SURFACE OF OUTERLITE (TEMPERED GLASS TO BE USED AT DOORS AND

PRODUCT: ALPOLIC - (1/2" DRY JOINT)

CONTRACTOR TO PROVIDE COLOUR/FINISH

SAMPLE FOR OWNER APPROVAL PRIOR TO

<u>LIGHT FIXTURE:</u>
REFER TO ELEC. SPEC. FOR LIGHT FIXTURE

EXTERIOR SIGNAGE: SIGNAGE TO BE PROVIDED BY AND INSTALLED

BY TENANT. SIGNAGE CONDUIT ROUGH-OUTS

TO BE COORDINATED WITH TENANT.

ALUMINUM COMPOSITE PANEL:

SEE MANUFACTURER'S STANDARD

STEEL COLUMN: PRODUCT: HHS TUBE, SQUARE

PRODUCT: ALPOLIC COLOUR: CNC CHARCOAL

ALUMINUM SLATS:

COLOUR: CHARCOAL

SIZE: 6"X1"

SIZE: TBD

COLOUR: WHITE

PRODUCT: LONGBOARD

FASCIA CANOPY - ALUMINUM COMPOSITE PANEL:

SIZE: 1220 x 2500-3050 x 8 mm

COLOUR: TE90 (WHITE)

SIZE: 1200 x 406 mm COLOUR: COBBLESTONE

ALUMINUM FRAMES

COLOUR: MÓUSE GRAY

ORDERING OF MATERIALS

ALUMINUM COMPOSITE PANEL: PRODUCT: ALPOLIC COLOUR: SILVER METALLIC

(OR SIMILAR REFLECTIVE COLOUR)

REFER TO DETAILS FOR PROFILE

SIDELIGHTS)

COLOUR: BLACK

FINISH: PLAIN

PANEL

MORTAR: TO MATCH BLOCK SEE MANUFACTURER'S STANDARD

SEE MANUFACTURER'S STANDARD

SEE MANUFACTURER'S STANDARD

COLOUR: CHELSEA

67 Lesmill Road Toronto, ON, M3B 2T8 T 416 425 2222 turnerfleischer.com

This drawing, as an instrument of service, is provided by and is the property of Turner Fleischer Architects Inc. The contractor must verify and accept responsibility for all dimensions and conditions on site and must notify Turner Fleischer Architects Inc. of any variations from the supplied information. This drawing is not to be scaled. The architect is not responsible for the accuracy of survey, structural, mechanical, electrical, etc., information shown on this drawing. Refer to the appropriate consultant's drawings before proceeding with the work. Construction must conform to alapplicable codes and requirements of authorities having jurisdiction. The contractor working from drawings not specifically marked 'For Construction' must assume full responsibility and bear costs for any corrections or damages resulting from his work.

NOTE:

ALL RTUs ARE TO BE SCREENED BY

fieldgate

LOUIS ST. LAURENT AVE. & BRONTE STREET SOUTH

MILTON, ON

BUILDING G

#SP-29/22 ELEVATIONS

PROJECT NO. 17.042 PROJECT DATE 2023-12-22 DRAWN BY CHECKED BY SCALE As indicated

A307

9